

## **FINAL SITE PLAN APPLICATION**

## PLANNING AND ZONING DEPARTMENT

**INSTRUCTIONS:** Complete form, sign, and date. See applicable application packet for all required checklist items.

			TACT INFO	RMATION		
APPLICANT	_	/illiam Reilly				
ADDRESS	-	71 Taughannock Blvd.				
CITY	Tru	ımansburg	STATE	NY	ZIP	14886
PHONE			EMAIL			
OWNER	Sai	me as above				
ADDRESS						
CITY			STATE		ZIP	
PHONE			EMAIL			
PRIMARY CON	NTAC	CT ☑APPLICANT ☑OWNER	OTHER	, PLEASE SPECIFY BELOW	V	
NAME						
PHONE			EMAIL			
		PROJEC	T SITE INI	ORMATION		
ADDRESS		1671 Taughannock Blvd.	, I SITE IIVI	ORIVIATION		
PARCEL NO(S)						
(-,		161-1				
			ECT INFO	RMATION		
PROJECT NAM	1E	Reilly Garage				
PROJECT DESCRIPTION		Construction of an accessory bu	uildina / d	lotachad garaga an ni	rivata racidar	200
		Construction of all accessory by	ulluling / C	letached garage on pi	ilvate resider	ice.
SKETCH PLAN REVIEW						
DATE(S)						
VALUATION		\$75,000				
Authorization	n: l ar	m the owner or am authorized by th	ne owner t	o sign and submit this a	pplication. I co	ertify under penalty
of perjury of the laws of the State of New York that the information on this application and all information submitted						
herewith is tru	ue, c	omplete, and correct.		1		
SIGNATURE		William Reilly			DATE 12/29/2	5
PRINT NAME		William Reilly				
CITY, STATE		Trumansburg, NY				





William Reilly

1671 Taughannock Blvd.

Trumansburg, NY 14886

10/25/25

Town of Ulysseys

Planning and Zoning Department

Narrative Statement

RE: 1671 Taughannock Blvd. Proposed Accessory building, permit application.

The purpose of this narrative is to request a permit for construction of an accessory building, on private residential property located at 1671 Taughannock Blvd.

Consideration of the sensitive nature of the Lakeshore and steep slope zones, and natural topography characteristics were taken into account during the design phase and proposed placement on the lot. The proposed accessory building is also replacing a previously existing garage structure from the same location, that was damaged / in a previous windstorm and falling tree accident- pictures of the previous structure, as well as existing conditions of where the stabilized natural steep slopes are to be maintained are included / attached to this proposal.

This proposed location allows for proper use / access from driveway, where old structure was, and does not require any more tree removals (Previous diseased Hemlock trees had fallen down, and been removed due to safety concerns here). This location also allows for minimal grading changes, to best fit within the natural topography and drainage pattern of the existing site.

The uphill side of the foundation will be partially buried 8'+'- in bank of existing hill, to minimize overall profile, and to limit disturbance of natural stormwater flow.

While the parcel is categorized as Lake Shore Zone, the area the garage is to be located is well above lake elevation (Over 50' above), and over 150' away horizontally.

The property does contain areas of steep slopes along the lakeshore, and beside an intermittent streambank, however there will not be any construction on or around steep slopes, (30+ feet away from top of any slopes), and an existing stabilized vegetation buffer will be maintained at all times.


During construction, silt logs will be placed below disturbed excavation site, to prevent any sediment runoff from leaving the site.


Post-Construction, the roof water will be directed to pervious garden / lawn areas, and excess will be collected by drainage stone trenches and directed to streambed via. HDPE pipe drain to eliminate any point source erosion potential.


I appreciate your time and consideration of this permit. If any further information is needed, please do not hesitate to ask.

Thank you,


William Reilly
-William Reilly

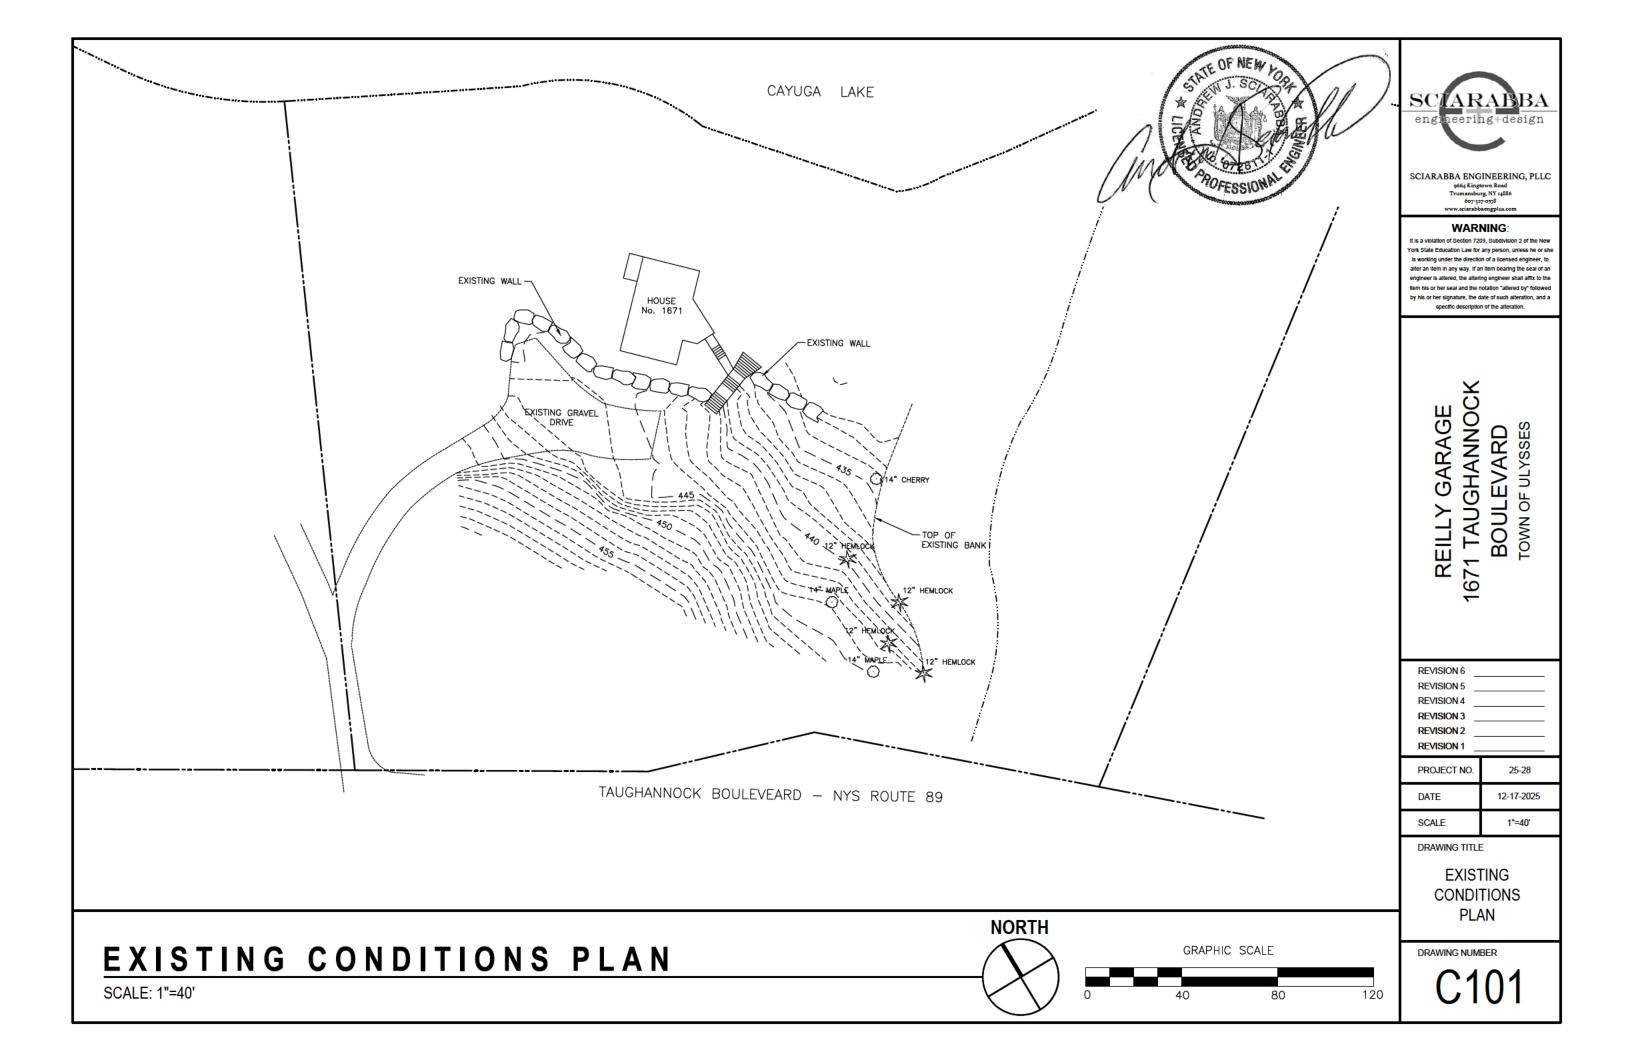

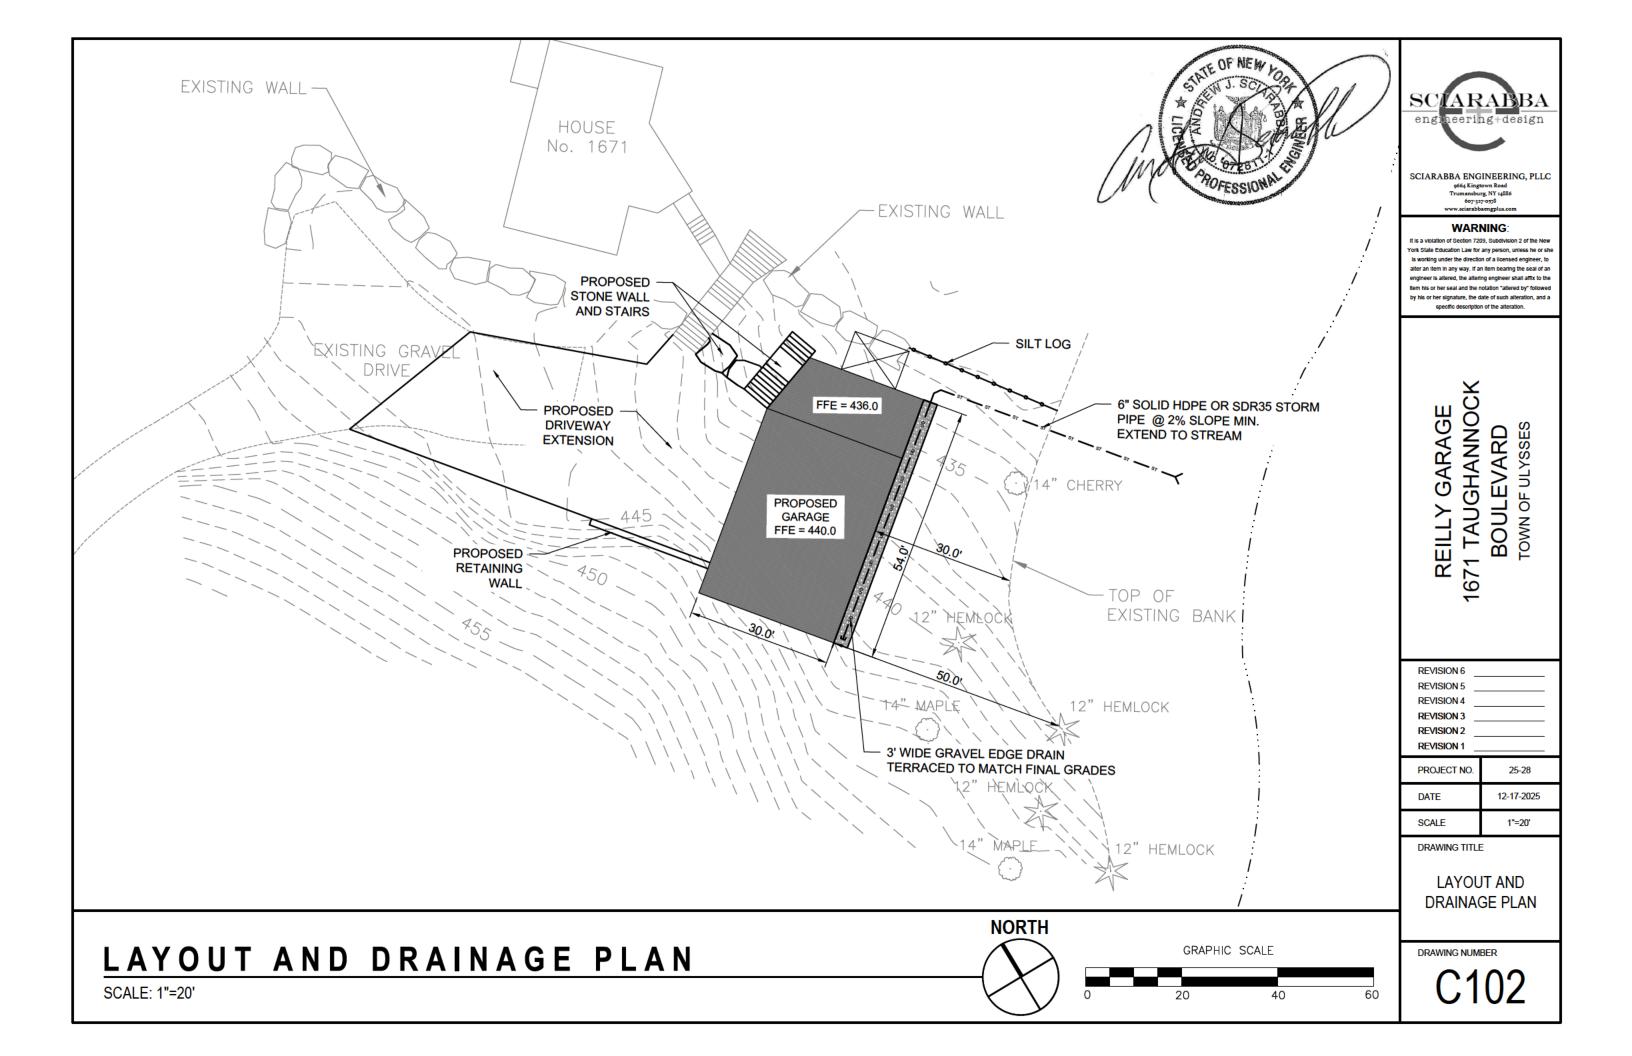

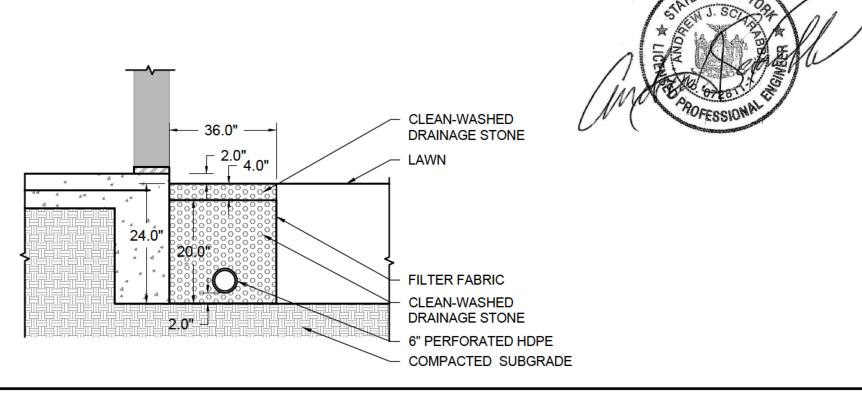

## GRAVEL EDGE DRAIN - NOT TO SCALE

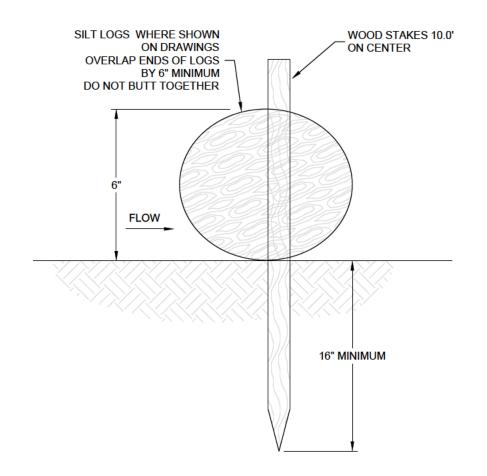



SCIARABBA ENGINEERING, PLLC

9664 Kingtown Road Trumaneburg, NY 14886 607-327-0578

## WARNING:

It is a violation of Section 7209, Subdivision 2 of the New York State Education Law for any person, unless he or she is working under the direction of a licensed engineer, to alter an Item in any way. If an Item bearing the seal of an engineer is altered, the altering engineer shall affix to the Item his or her seal and the notation "altered by" followed by his or her signature, the date of such alteration, and a specific description of the alteration.

# REILLY GARAGE 1671 TAUGHANNOCK BOULEVARD TOWN OF ULYSSES

REVISION 6	
REVISION 5	
REVISION 4	
REVISION 3	
REVISION 2	
REVISION 1	

PROJECT NO.	25-28
DATE	12-17-2025
SCALE	NOT TO SCALE

DRAWING TITLE


**DETAILS** 

DRAWING NUMBER

C103

SILT LOG - NOT TO SCALE



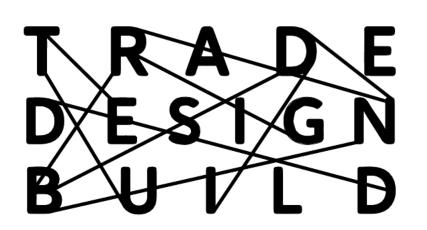

# REILLY GARAGE

1671 TAUGHANNOCK BLVD, TRUMANSBURG, NY 14886 BILL REILLY

25037

## DRAWING LIST

G0 00 COVER SHEET S1 00 FOUNDATION PLAN S1 01 FIRST FLOOR FRAMING PLAN S1 02 SECOND FLOOR FRAMING PLAN S1 03 ROOF FRAMING PLAN S3 01 ROOF FRAMING SECTIONS A1.01 FIRST FLOOR PLAN A1.02 SECOND FLOOR PLAN A1.03 ROOF PLAN A2.01 EXTERIOR ELEVATIONS A2.02 EXTERIOR ELEVATIONS A3.01 BUILDING SECTIONS A3.51 WALL SECTIONS

## **GENERAL NOTES**

- THESE DRAWINGS AND SPECIFICATIONS INCLUDING THE DESIGN AND ARRANGEMENTS REPRESENTED HEREIN ARE THE PROPERTY OF TRADE DESIGN BUILD ARCHITECTURE. NO PART THEREOF SHALL BE COPIED, DISCLOSED TO OTHERS, OR USED IN CONJUNCTION WITH ANY WORK OR PROJECT OTHER THAN THAT FOR WHICH THEY HAVE BEEN PREPARED WITHOUT THE EXPRESS CONSENT OF TRADE DESIGN BUILD ARCHITECTURE.
- THE OWNER AND/OR CONTRACTOR SHALL HOLD THE ARCHITECT HARMLESS FROM AND AGAINST ALL CLAIMS, DAMAGES, LOSSES AND EXPENSES RESULTING FROM THE PERFORMANCE OF THE WORK BY THE CONTRACTOR.
- THE ARCHITECT SHALL NOT BE RESPONSIBLE WHERE CONSTRUCTION DEVIATES FROM THESE DRAWINGS. CHANGES TO THE DRAWINGS WITHOUT WRITTEN CONSENT FROM THE ARCHITECT SHALL BE THE RESPONSIBILITY OF THE PARTY IMPLEMENTING THE CHANGE.
- ALL WORK, MATERIALS AND EQUIPMENT SHALL MEET THE LATEST REQUIREMENTS OF ALL APPLICABLE FEDERAL, STATE AND LOCAL CODES AND THE REQUIREMENTS OF THE AUTHORITY HAVING JURISDICTION
- CONSTRUCTION MEANS AND METHODS, TECHNIQUES, PROCEDURES AND SAFETY PRECAUTIONS ARE THE SOLE RESPONSIBILITY OF THE CONTRACTOR.
- ALL WORK TO BE INSTALLED IN ACCORDANCE WITH LATEST MANUFACTURER, ASTM OR OTHER RECOGNIZED INDUSTRY STANDARDS.
- THE CONTRACTOR IS RESPONSIBLE FOR THE DESIGN OF HVAC, ELECTRICAL, PLUMBING AND UTILITY SYSTEMS.
- DO NOT SCALE DRAWINGS, USE GIVEN DIMENSIONS. DRAWING SCALE IS FOR REFERENCE ONLY. DIMENSIONS SHOWN ARE FROM FACE OF FRAMING.
- IT IS THE CONTRACTORS RESPONSIBILITY TO FIELD VERIFY AND MAINTAIN ALL DIMENSIONS BEFORE AUTHORIZING FABRICATION OR PROCEEDING WITH CONSTRUCTION OF ANY

## **CODE REVIEW**

BUILDING CODE REVIEW DONE IN ACCORDANCE WITH THE 2020 RESIDENTIAL BUILDING CODE OF NEW YORK STATE (2020 RBCNYS), AND THE 2020 ENERGY CONSERVATION CODE OF NEW YORK STATE (2020 ECCNYS)

ENERGY CODE COMPLIANCE THROUGH PRESCRIPTIVE METHODS IN ACCORDANCE WITH TABLE R402.1.2, CLIMATE ZONE 6 OPTION 1

MEP SYSTEMS TO BE DETERMINED, FINAL DESIGN & ENERGY CODE COMPLIANCE BY MEP

STRUCTURAL DESIGN DONE IN COLLABORATION WITH TAITEM ENGINEERING

PROJECT DETAILS

PROJECT NAME:

PROJECT NO: REILLY GARAGE

CLIENT NAME: PROJECT ADDRESS: BILL REILLY 1671 TAUGHANNOCK BLVD, TRUMANSBURG,

NY 14886

CONSULTANT DETAILS

REVISION SCHEDULE

REVISION NO.

DRAWING DETAILS


DRAWING NAME: **COVER SHEET** 

DRAWING NO:

ISSUE DATE:


SEPTEMBER 26, 2025

ISSUE DATE

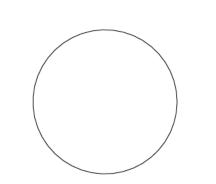

© 2013 TRADE DESIGN BUILD© 2013 TRADE DESIGN BUILD These drawings and specifications including the design and arrangements represented herein are the property of Trade Design Build. No part thereof shall be copied, disclosed to others, or used in conjunction with any work or project other than that for which they have been prepared without the

express consent of Trade Design Build.

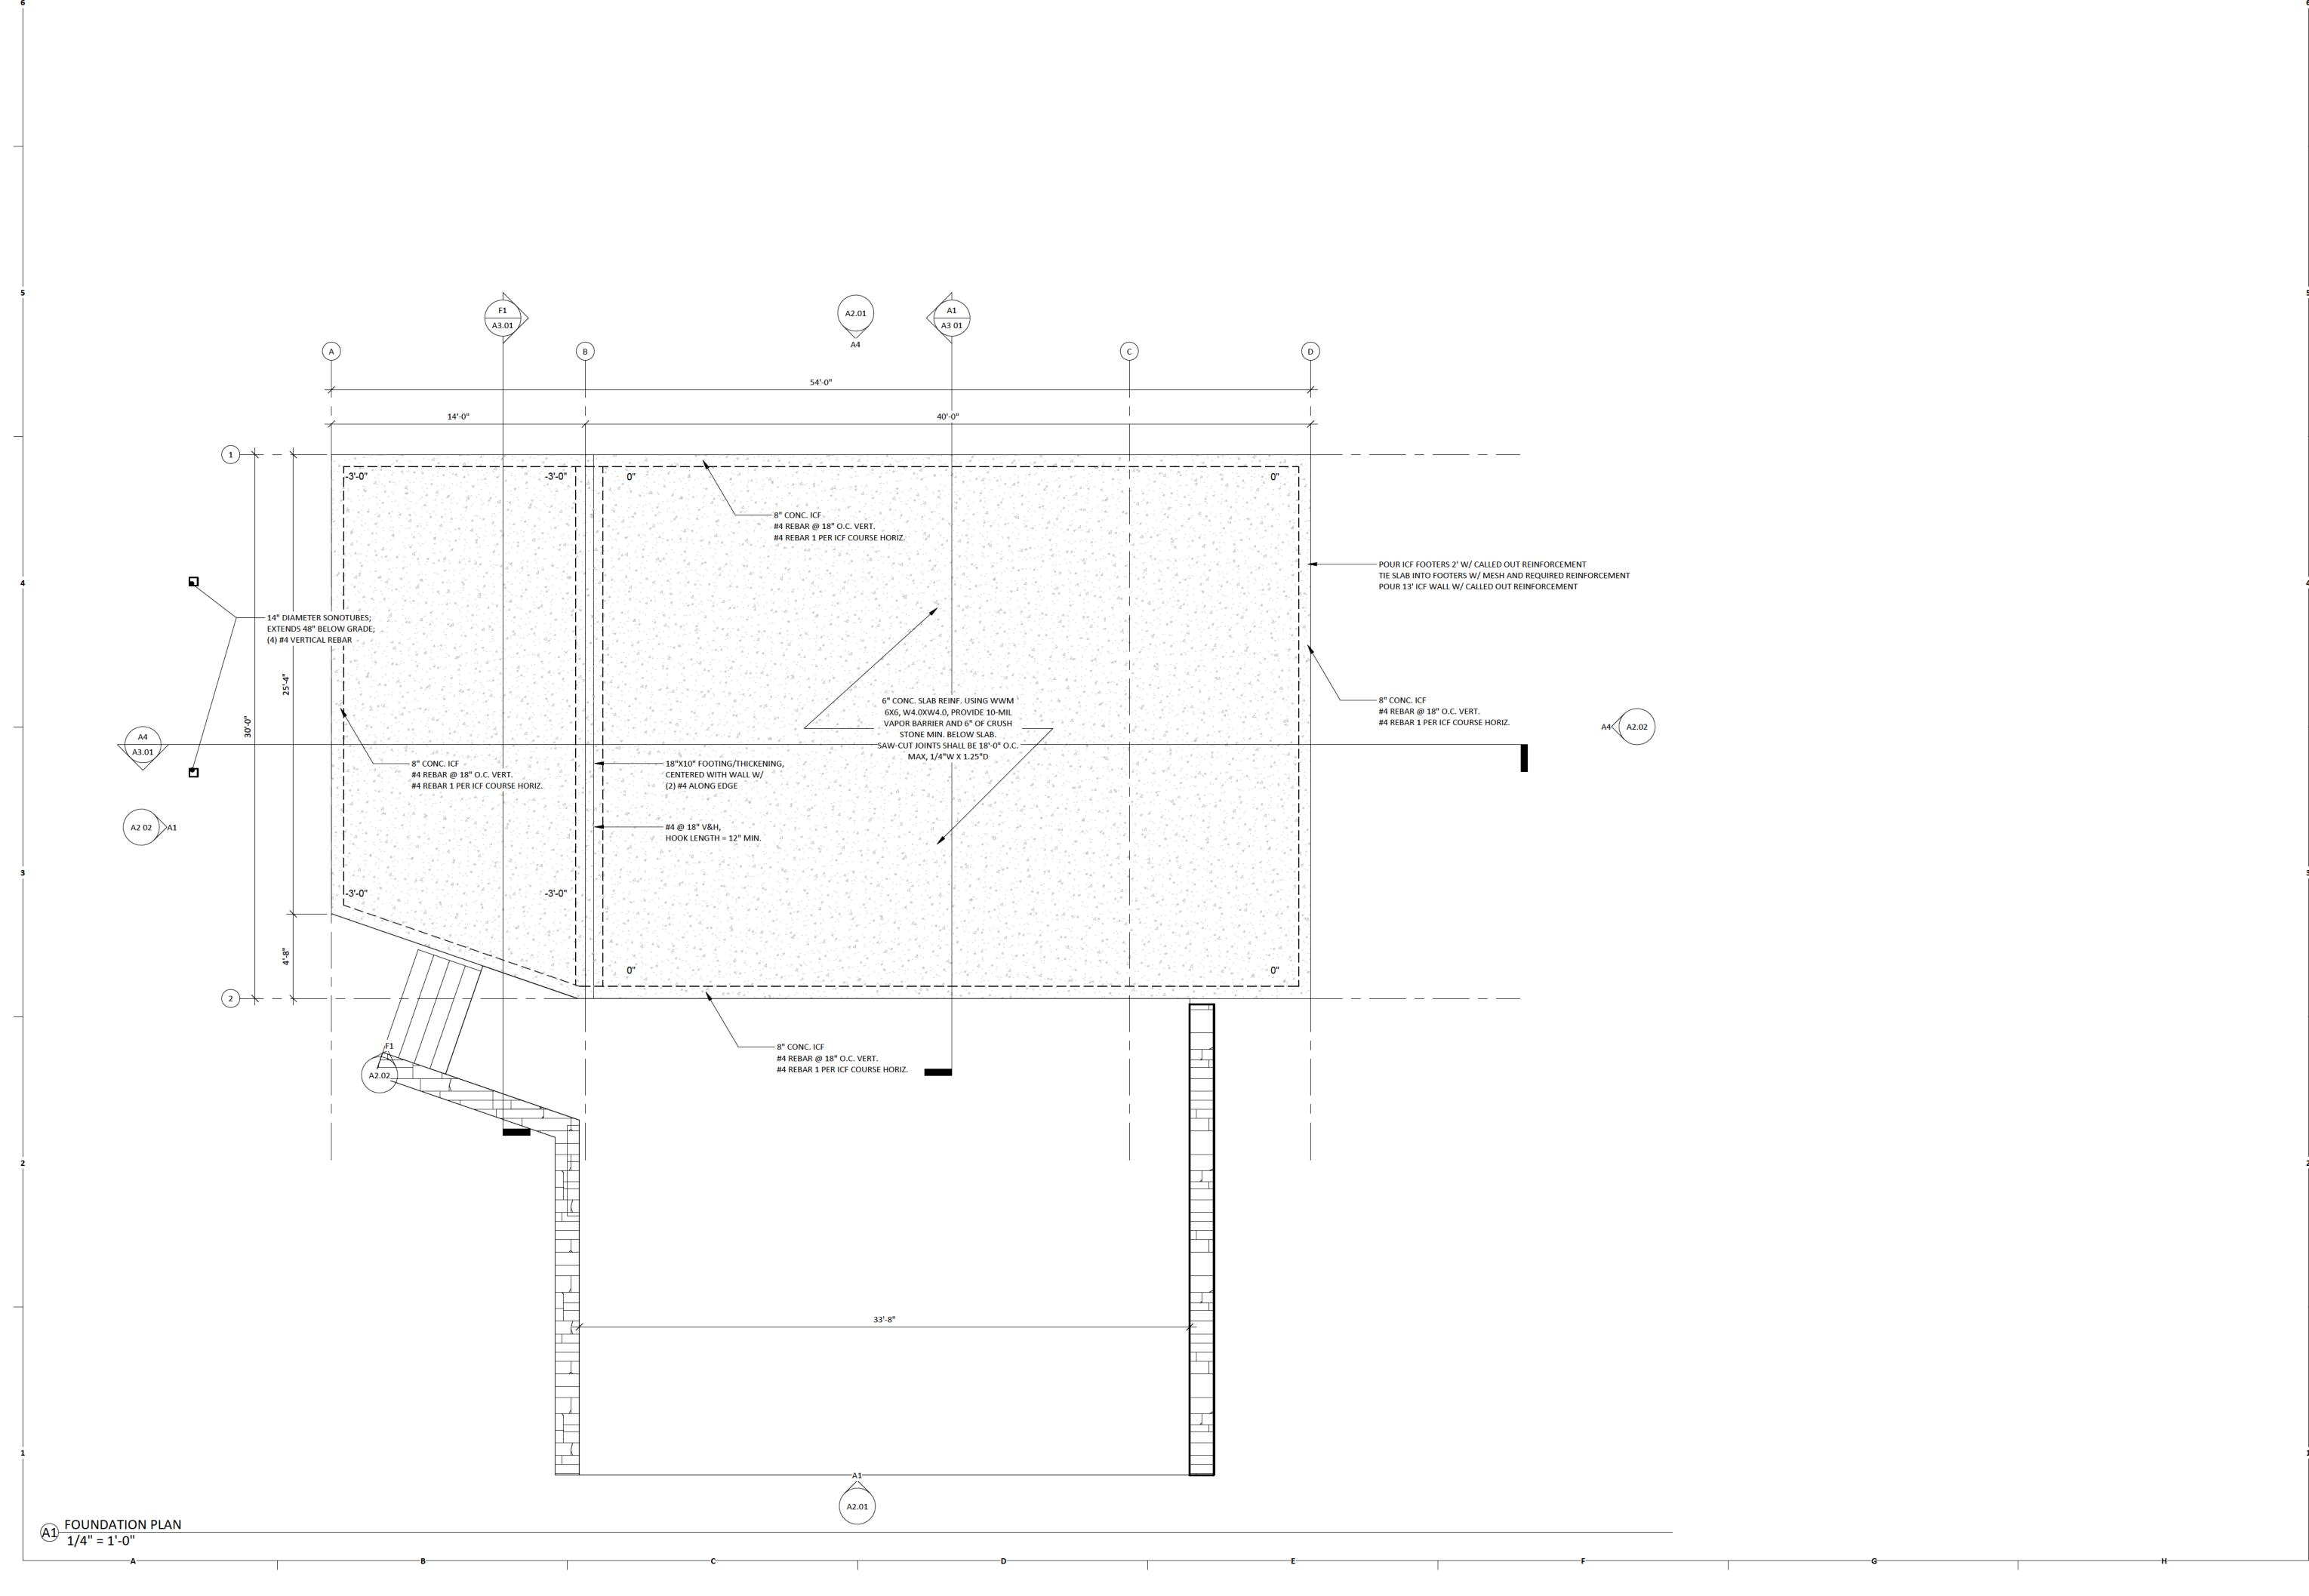

TRADE
DESIGN BUILD 1520 TRUMANSBURG ROAD 117HACA NEW YORK 14850 WWW.TRADEDESIGNBUILD.COM

PROJECT NO:

25037

PROJECT DETAILS

PROJECT NAME:

REILLY GARAGE

PROJECT ADDRESS:

1671 TAUGHANNOCK BLVD, BILL REILLY TRUMANSBURG, NY 14886

CONSULTANT DETAILS

REVISION SCHEDULE

REVISION NO.

**ISSUE DATE** 

DRAWING DETAILS

FOUNDATION PLAN


DRAWING NO:

S1.00

ISSUE DATE:

SEPTEMBER 26, 2025


2025 J

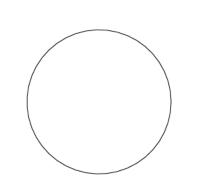

© 2013 TRADE DESIGN BUILD® 2013 TRADE DESIGN BUILD

These drawings and specifications including the design and arrangements represented herein are the property of Trade Design Build. No part thereof shall be copied, disclosed to others, or used in conjunction with any work or project other than that for which they have been prepared without the

express consent of Trade Design Build.

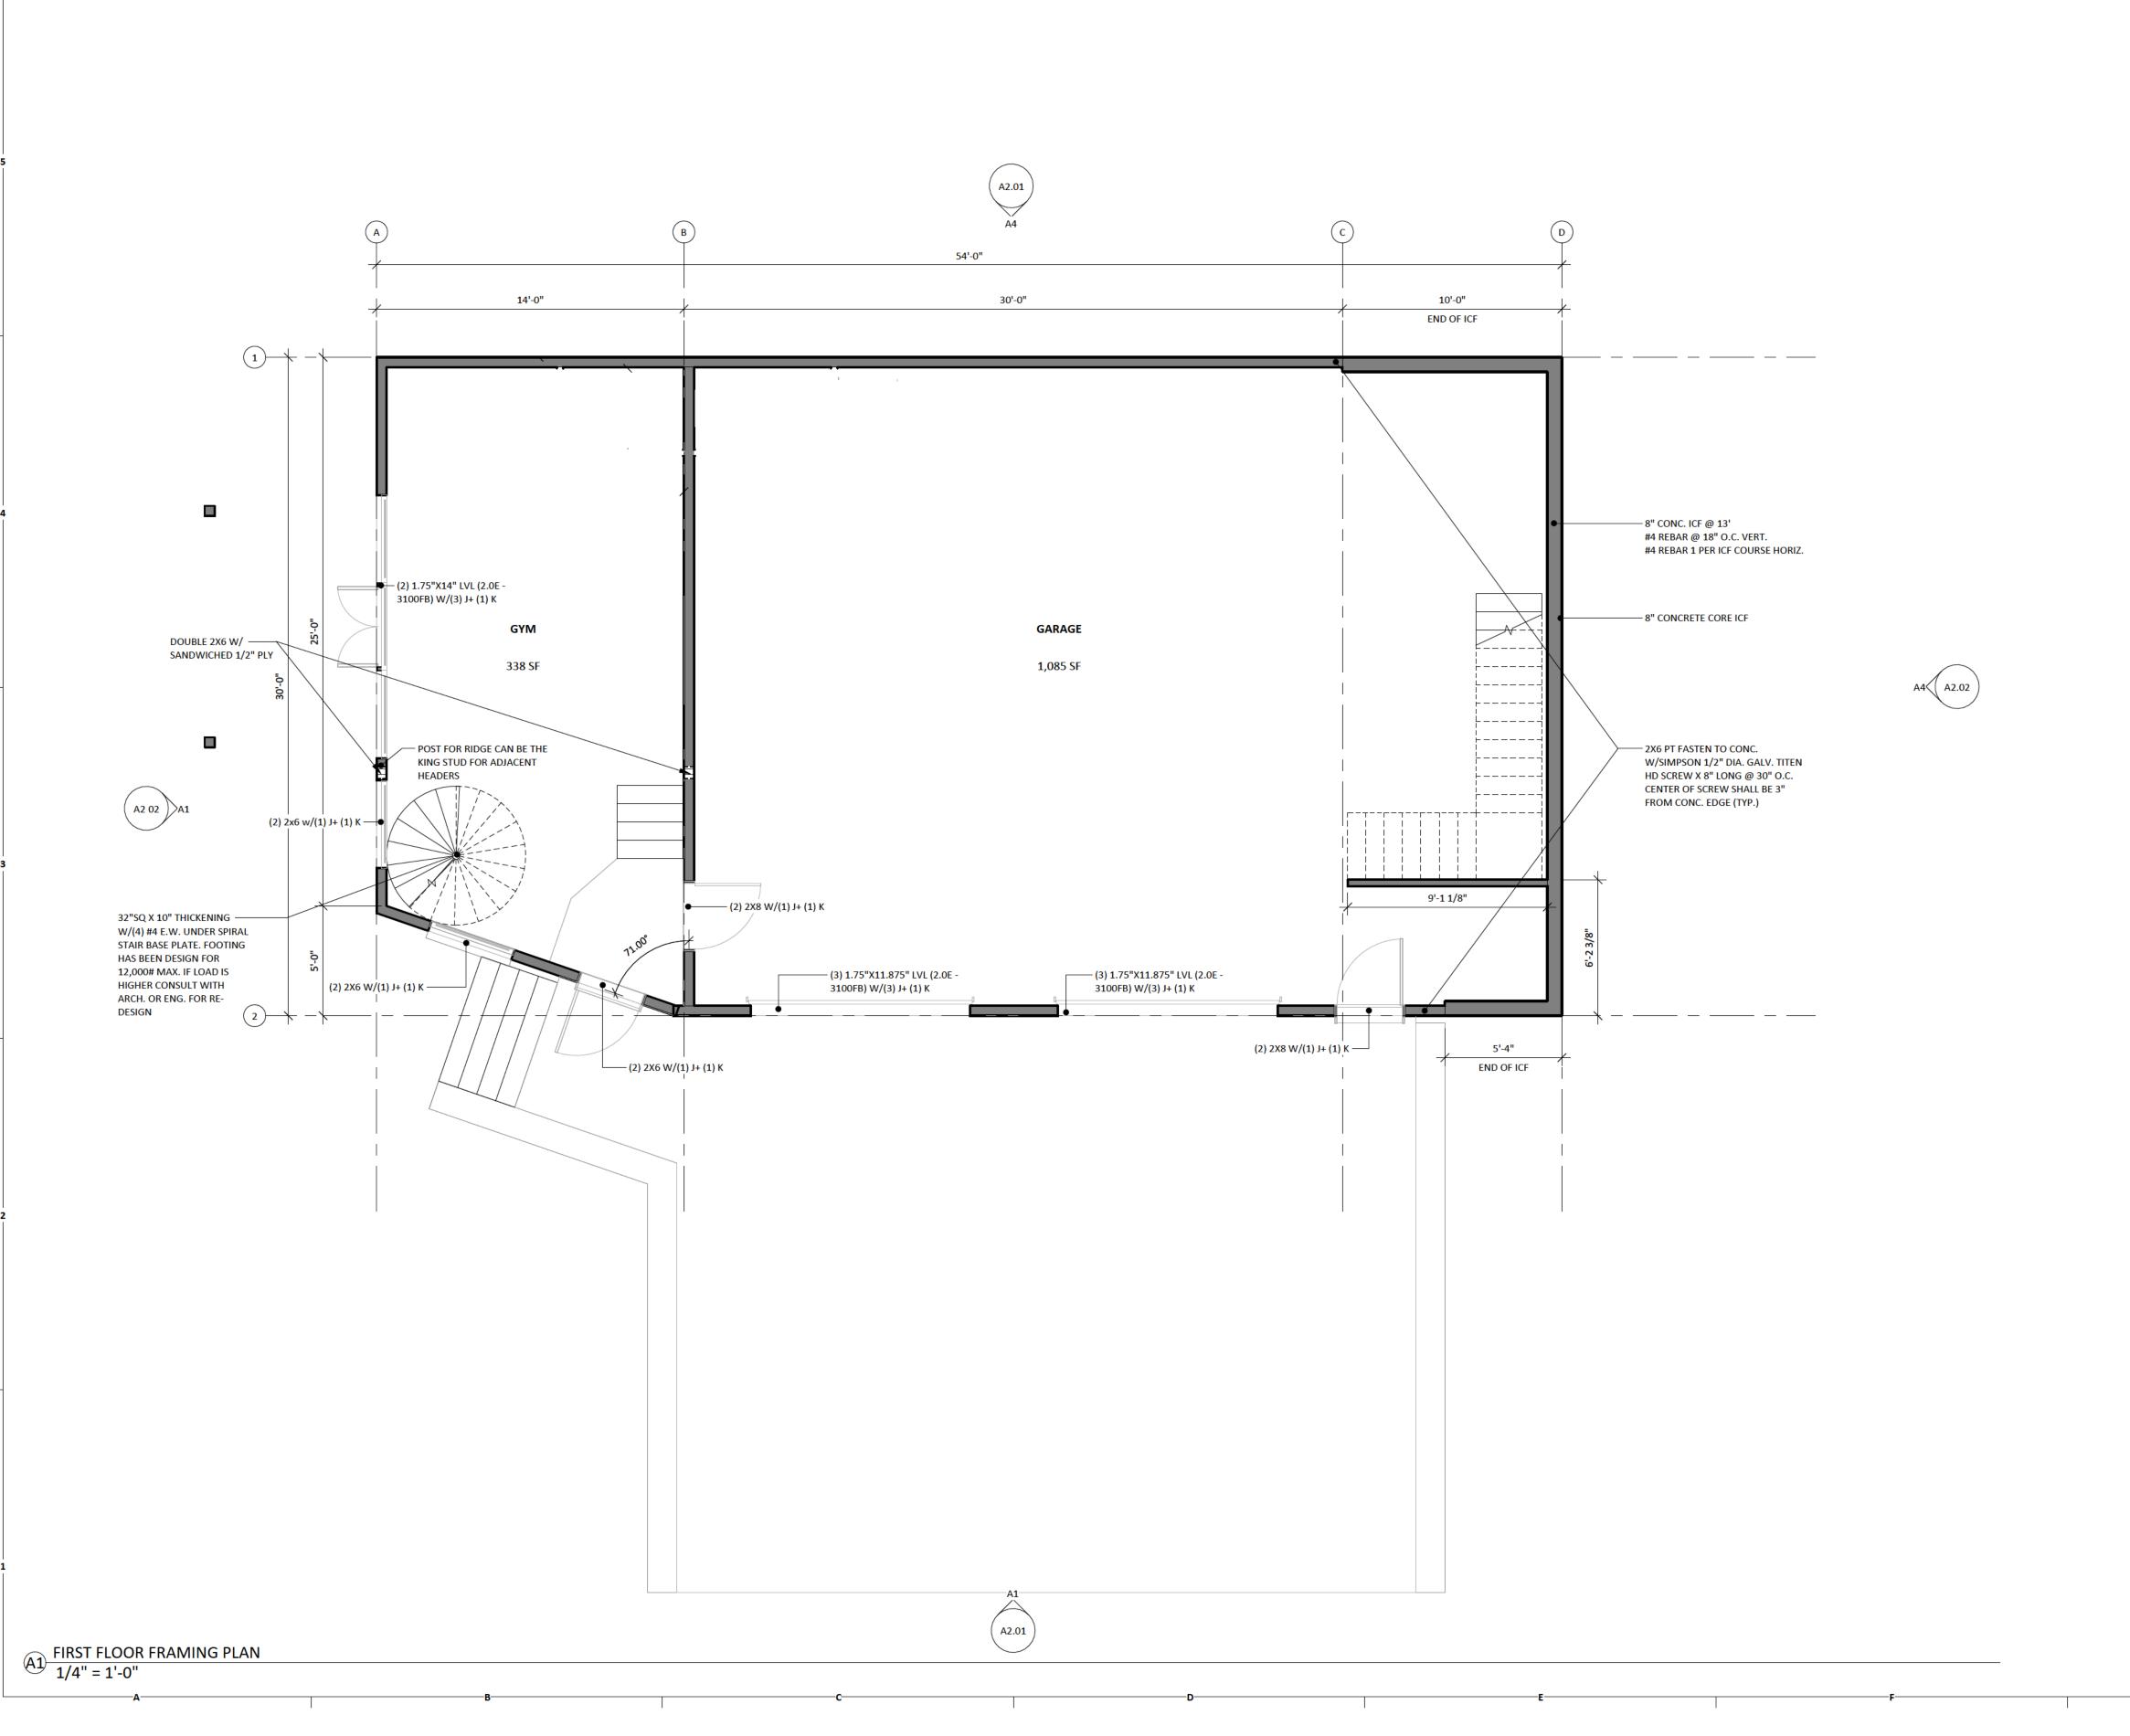

TRADE
DESIGN BUILD 1520 TRUMANSBURG ROAD ITHACA NEW YORK 14850 WWW.TRADEDESIGNBUILD.COM

PROJECT NO:

25037

PROJECT DETAILS

PROJECT NAME:
REILLY GARAGE

PROJECT ADDRESS:

1671 TAUGHANNOCK BLVD, BILL REILLY TRUMANSBURG, NY 14886

CONSULTANT DETAILS

REVISION SCHEDULE

REVISION NO.

DRAWING DETAILS

DRAWING NAME:

FIRST FLOOR FRAMING PLAN

DRAWING NO:


S1.01

ISSUE DATE:

DRAWN BY:

ISSUE DATE

SEPTEMBER 26, 2025

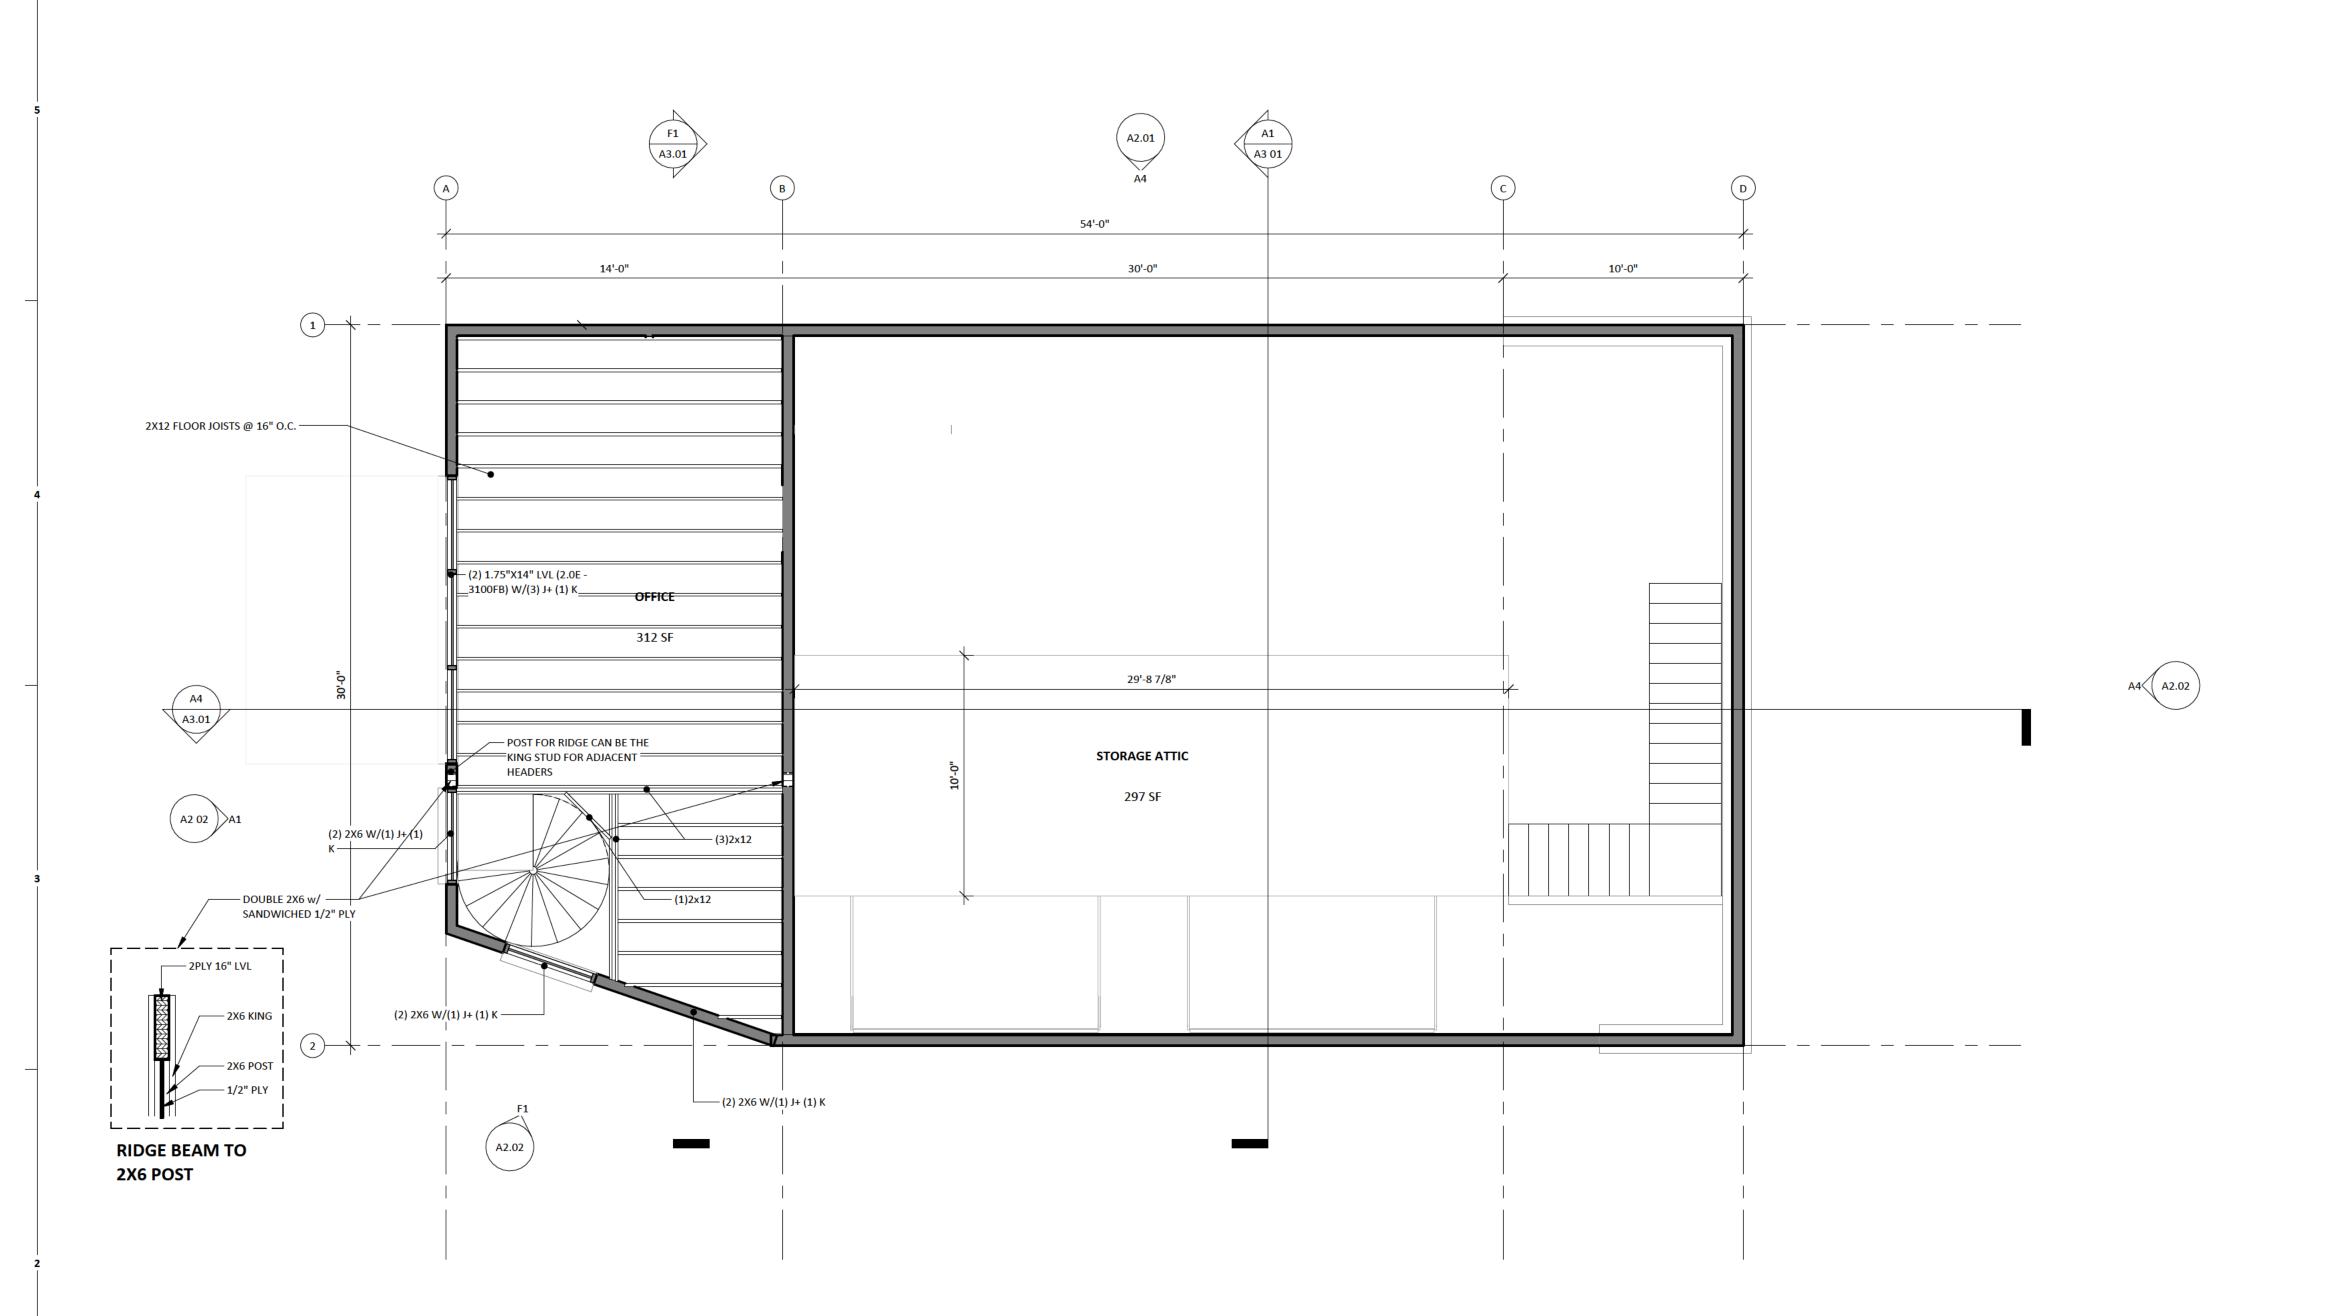

PROJECT NO:

25037

PROJECT DETAILS

PROJECT NAME: REILLY GARAGE

PROJECT ADDRESS:

1671 TAUGHANNOCK BLVD, BILL REILLY TRUMANSBURG, NY 14886

CONSULTANT DETAILS

REVISION SCHEDULE

**REVISION NO.** 

DRAWING DETAILS

DRAWING NAME:

SECOND FLOOR FRAMING PLAN

DRAWING NO:

ISSUE DATE: SEPTEMBER 26, 2025


DRAWN BY:

ISSUE DATE

© 2013 TRADE DESIGN BUILD© 2013 TRADE DESIGN BUILD These drawings and specifications including the design and arrangements represented herein are the property of Trade Design Build. No part thereof shall be copied, disclosed to others, or used in conjunction with any work or project other than that for which they have been prepared without the express consent of Trade Design Build.

( A2.01 )

SECOND FLOOR FRAMING PLAN
1/4" = 1'-0"

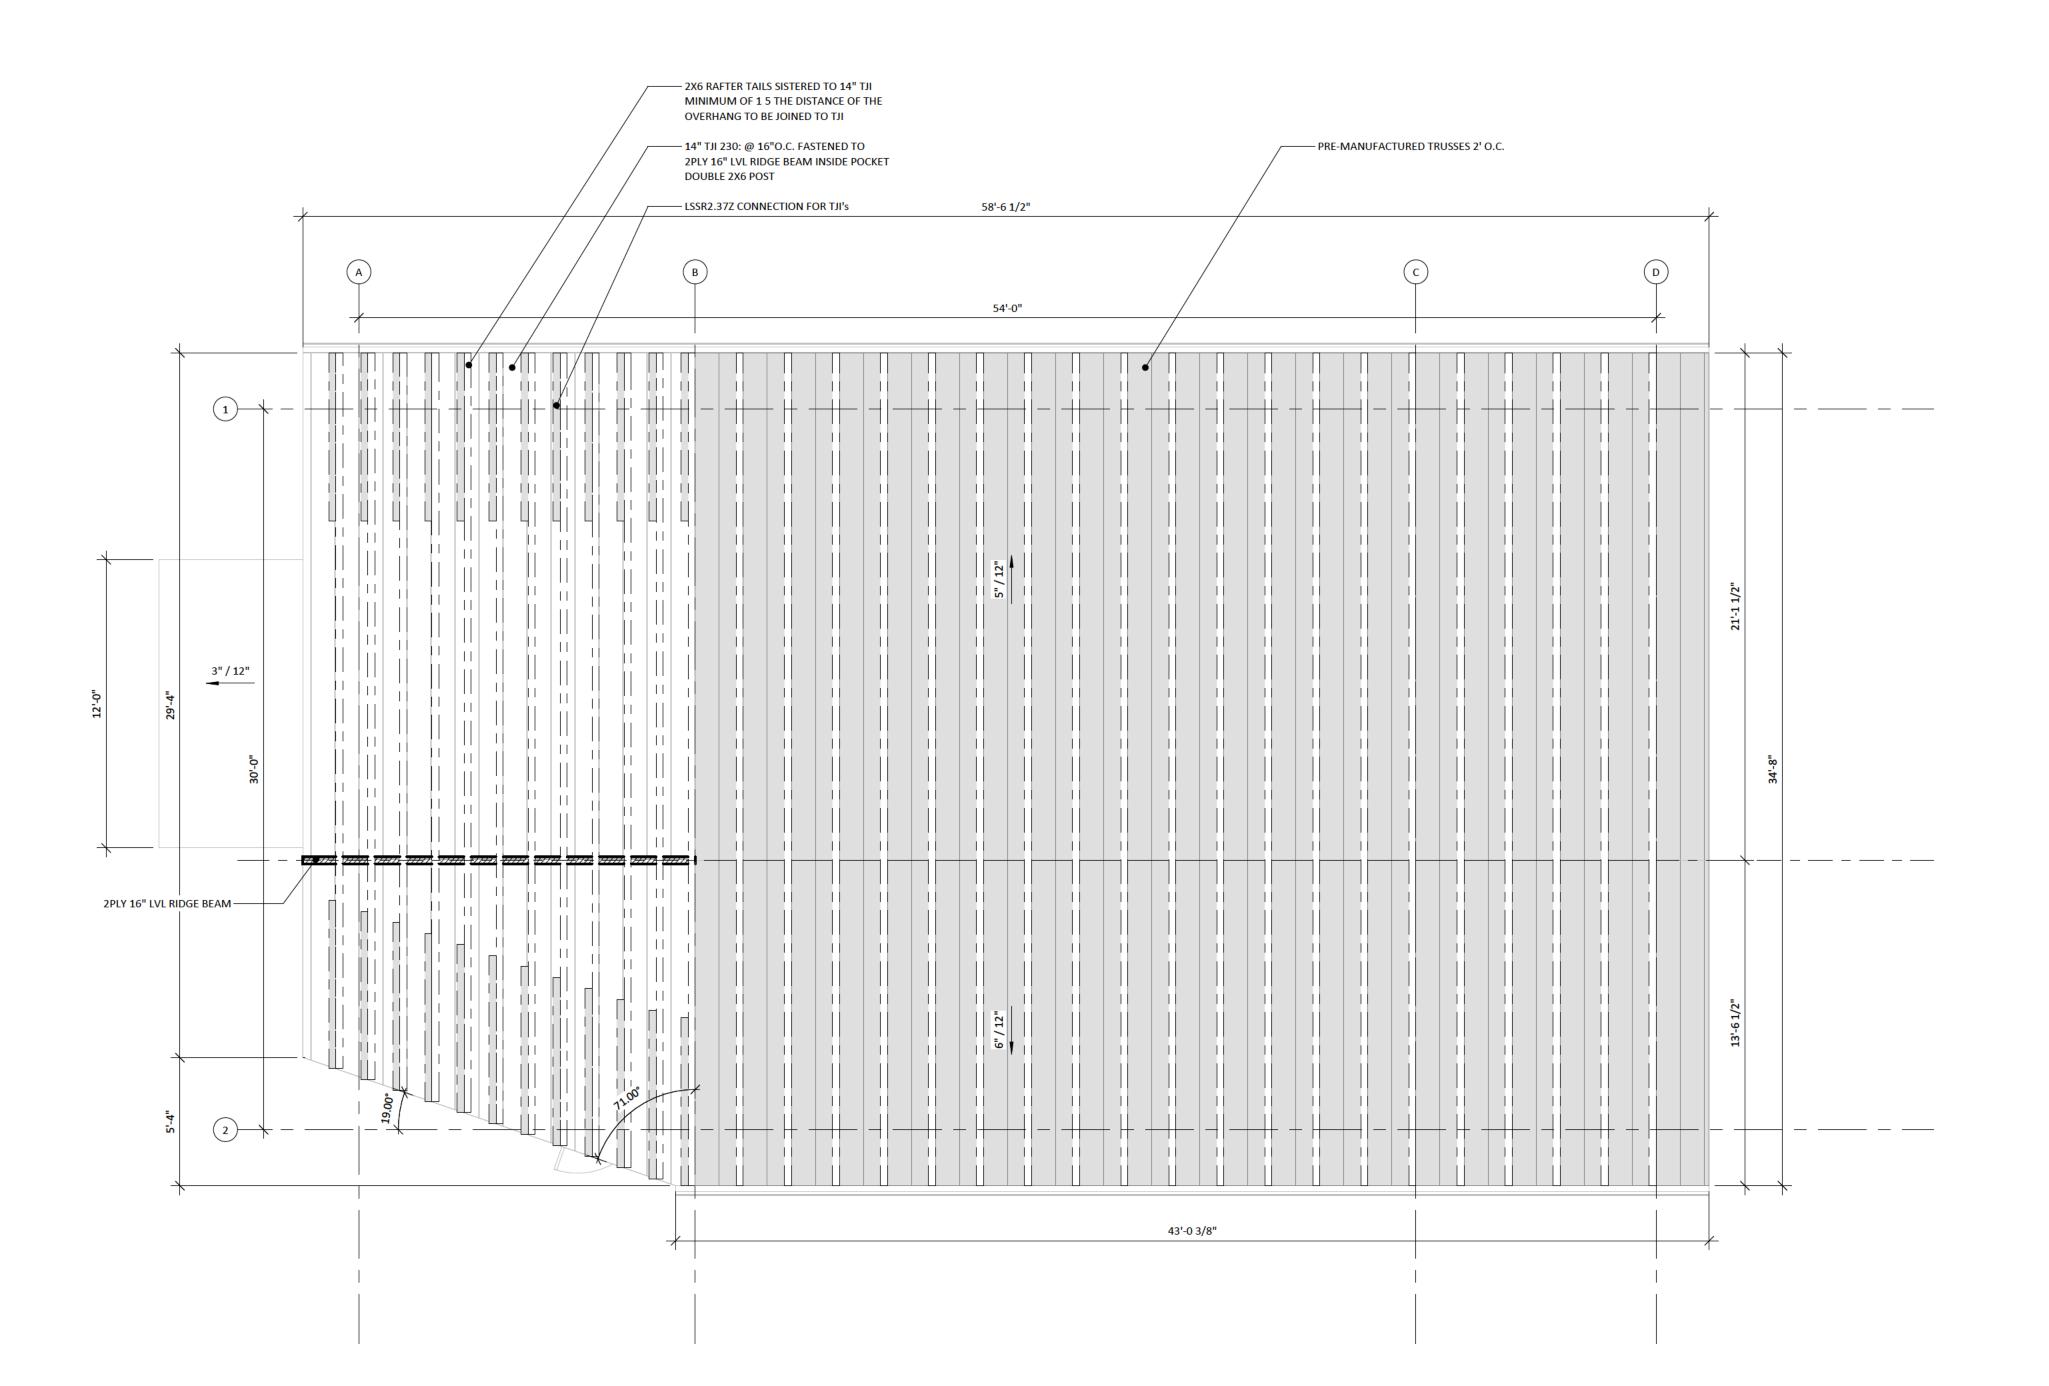

PROJECT NO:

25037

PROJECT DETAILS

PROJECT NAME: REILLY GARAGE

PROJECT ADDRESS:

1671 TAUGHANNOCK BLVD, BILL REILLY TRUMANSBURG, NY 14886

CONSULTANT DETAILS

REVISION SCHEDULE

REVISION NO.

DRAWING DETAILS

DRAWING NAME:

ROOF FRAMING PLAN

DRAWING NO:


ISSUE DATE: SEPTEMBER 26, 2025

DRAWN BY:

ISSUE DATE

© 2013 TRADE DESIGN BUILD© 2013 TRADE DESIGN BUILD These drawings and specifications including the design and arrangements represented herein are the property of Trade Design Build. No part thereof shall be copied, disclosed to others, or used in conjunction with any work or project other than that for which they have been prepared without the express consent of Trade Design Build.

ROOF FRAMING PLAN
1/4" = 1'-0"

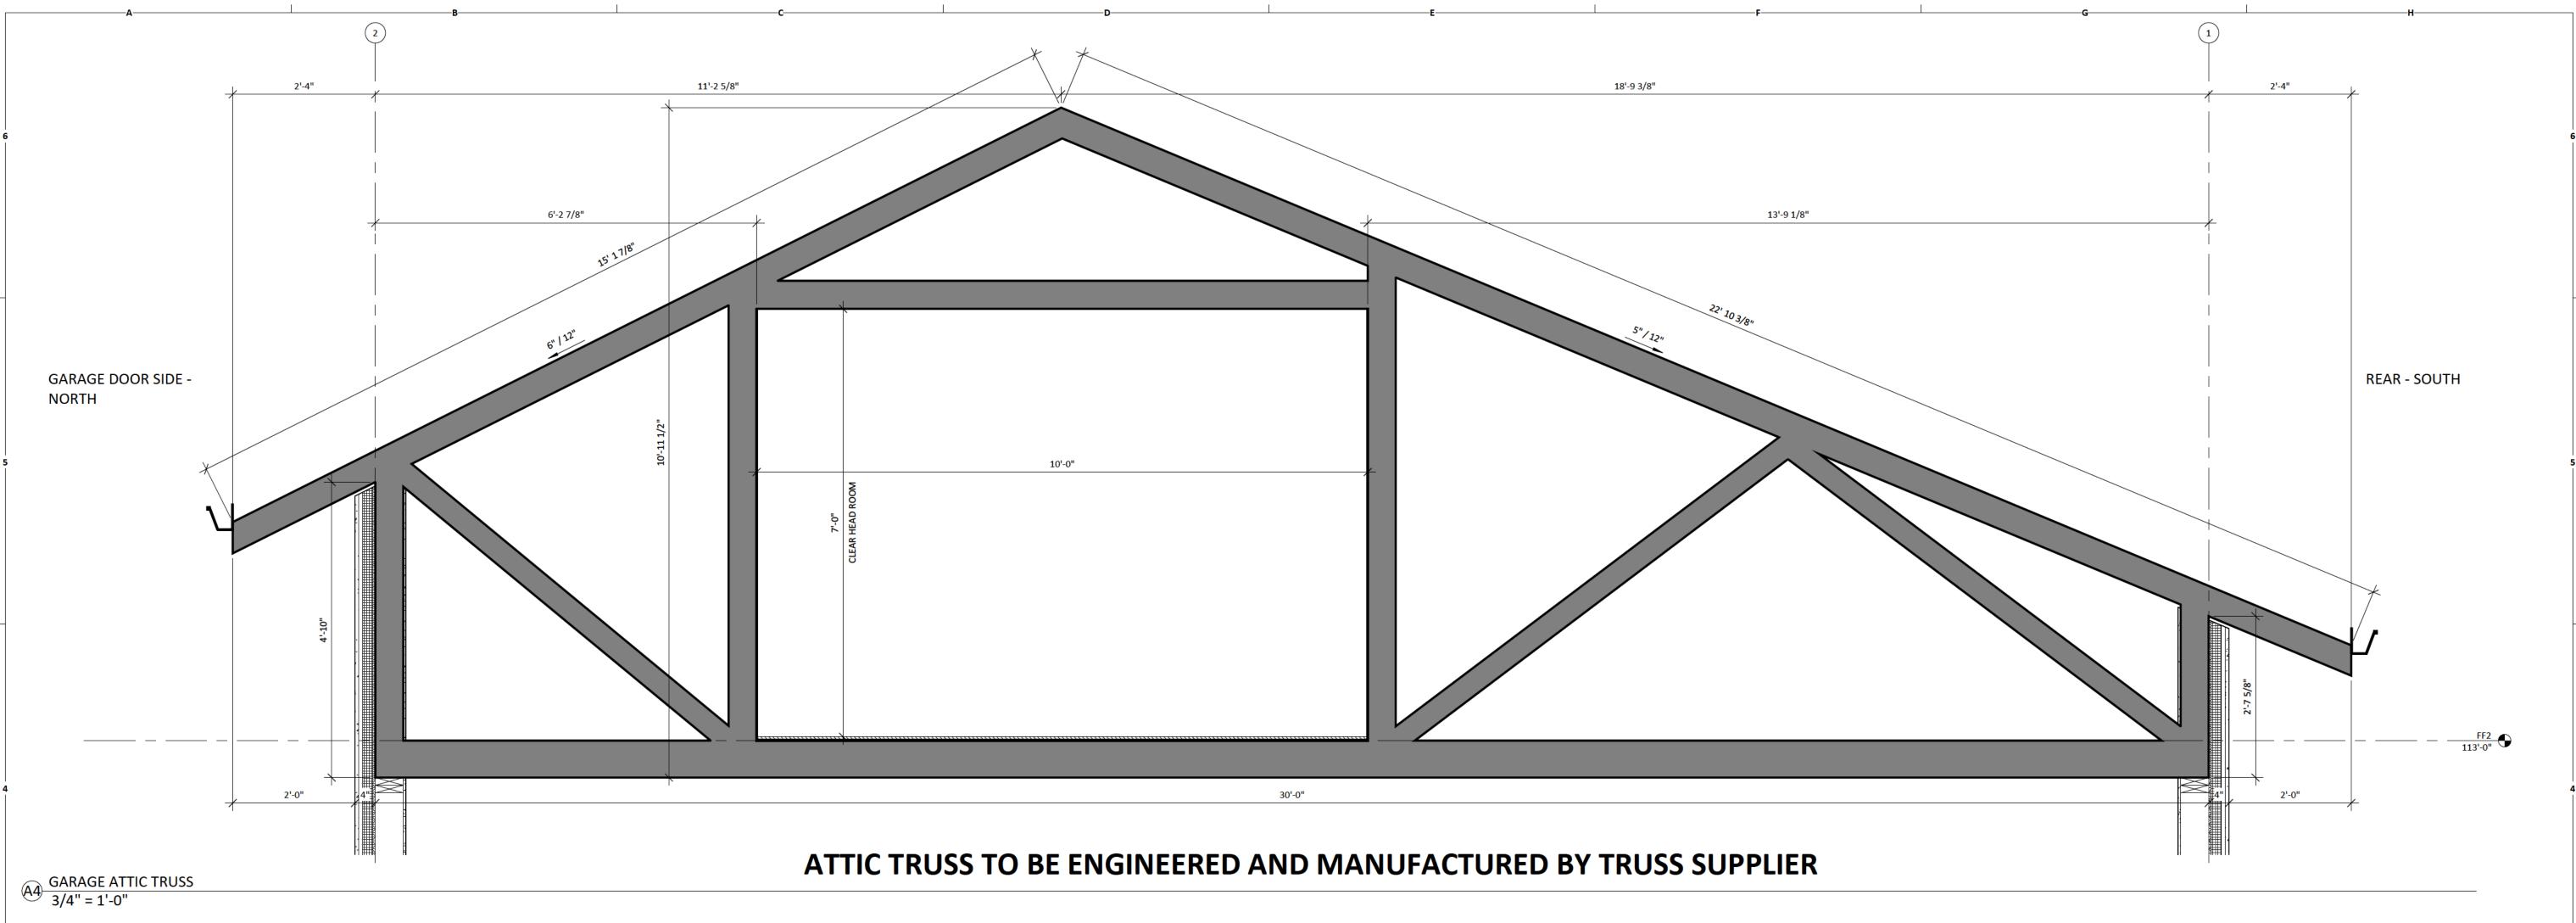

TRADE
DESIGN BUILD 1520 TRUMANSBURG ROAD ITHACA NEW YORK 14850 WWW.TRADEDESIGNBUILD.COM

PROJECT DETAILS

PROJECT NAME:

PROJECT NAME:
REILLY GARAGE

PROJECT ADDRESS:

TRUMANSBURG, NY 14886

1671 TAUGHANNOCK BLVD, BILL REILLY

CONSULTANT DETAILS

REVISION SCHEDULE

REVISION NO.

DRAWING DETAILS

ROOF FRAMING SECTIONS

ISSUE DATE

DRAWING NO:


DRAWING NAME:

S3.01

DRAWN BY:

ISSUE DATE:

SEPTEMBER 26, 2025

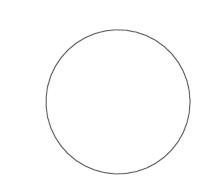

## 54'-0" 30'-0" 14'-0" 10'-0" END OF ICF \_ \_ \_ \_ \_ \_ \_ \_ \_ \_ \_ \_ \_ - APPROXIMATE RISE/RUN; 7 3/8 - 10 GYM GARAGE 338 SF 1,085 SF A4 A3.01 — APPROXIMATE RISE/RUN; 7 1/4 - 10 9'-1 1/8" APPROXIMATE RISE/RUN; 7 1/4 - 10 END OF ICF

A1 FIRST FLOOR PLAN
1/4" = 1'-0"

## WINDOW SCHEDULE

TAG	WIDTH	HEIGHT	MAUFACTURER	MAKE	ANGLE
G1	4'-0"	7'-0"	MARVIN	ESSENTIAL	
G2	4'-0"	2'-0"	MARVIN	ESSENTIAL	
G3	4'-0"	5'-9"	MARVIN	ESSENTIAL	
G4	4'-0"	7'-0"	MARVIN	ESSENTIAL	22.62
G5	4'-0"	1'-7"	MARVIN	ESSENTIAL	22.62
G6	4'-0"	3'-4 3/4"	MARVIN	ESSENTIAL	22.62
G7	4'-0"	3'-3 1/4"	MARVIN	ESSENTIAL	26.57
G8	4'-0"	6'-10 3/4"	MARVIN	ESSENTIAL	9.25

## DOOR SCHEDULE

TAG WIDTH		HEIGHT
ED1	10'-0"	11'-0"
ED2	3'-0"	6'-8"
ED3	3'-8"	6'-10"
ID1	3'-0"	6'-8"
ID2	2'-4"	6'-8"
ID3	2'-6"	6'-8"

TRADE
DESIGN BUILD 1520 TRUMANSBURG
ITHACA NEW YORK :

PROJECT NO:

25037

PROJECT DETAILS

PROJECT NAME:

REILLY GARAGE

PROJECT ADDRESS:

1671 TAUGHANNOCK BLVD, BILL REILLY TRUMANSBURG, NY 14886

CONSULTANT DETAILS

\_\_\_\_

REVISION SCHEDULE

REVISION NO.

ISSUE DATE

DRAWING DETAILS

DRAWING NAME:

DRAWING NO:


FIRST FLOOR PLAN


A1 01

ISSUE DATE:

DRAV

SEPTEMBER 26, 2025

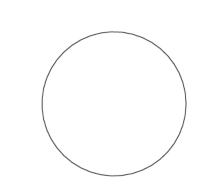

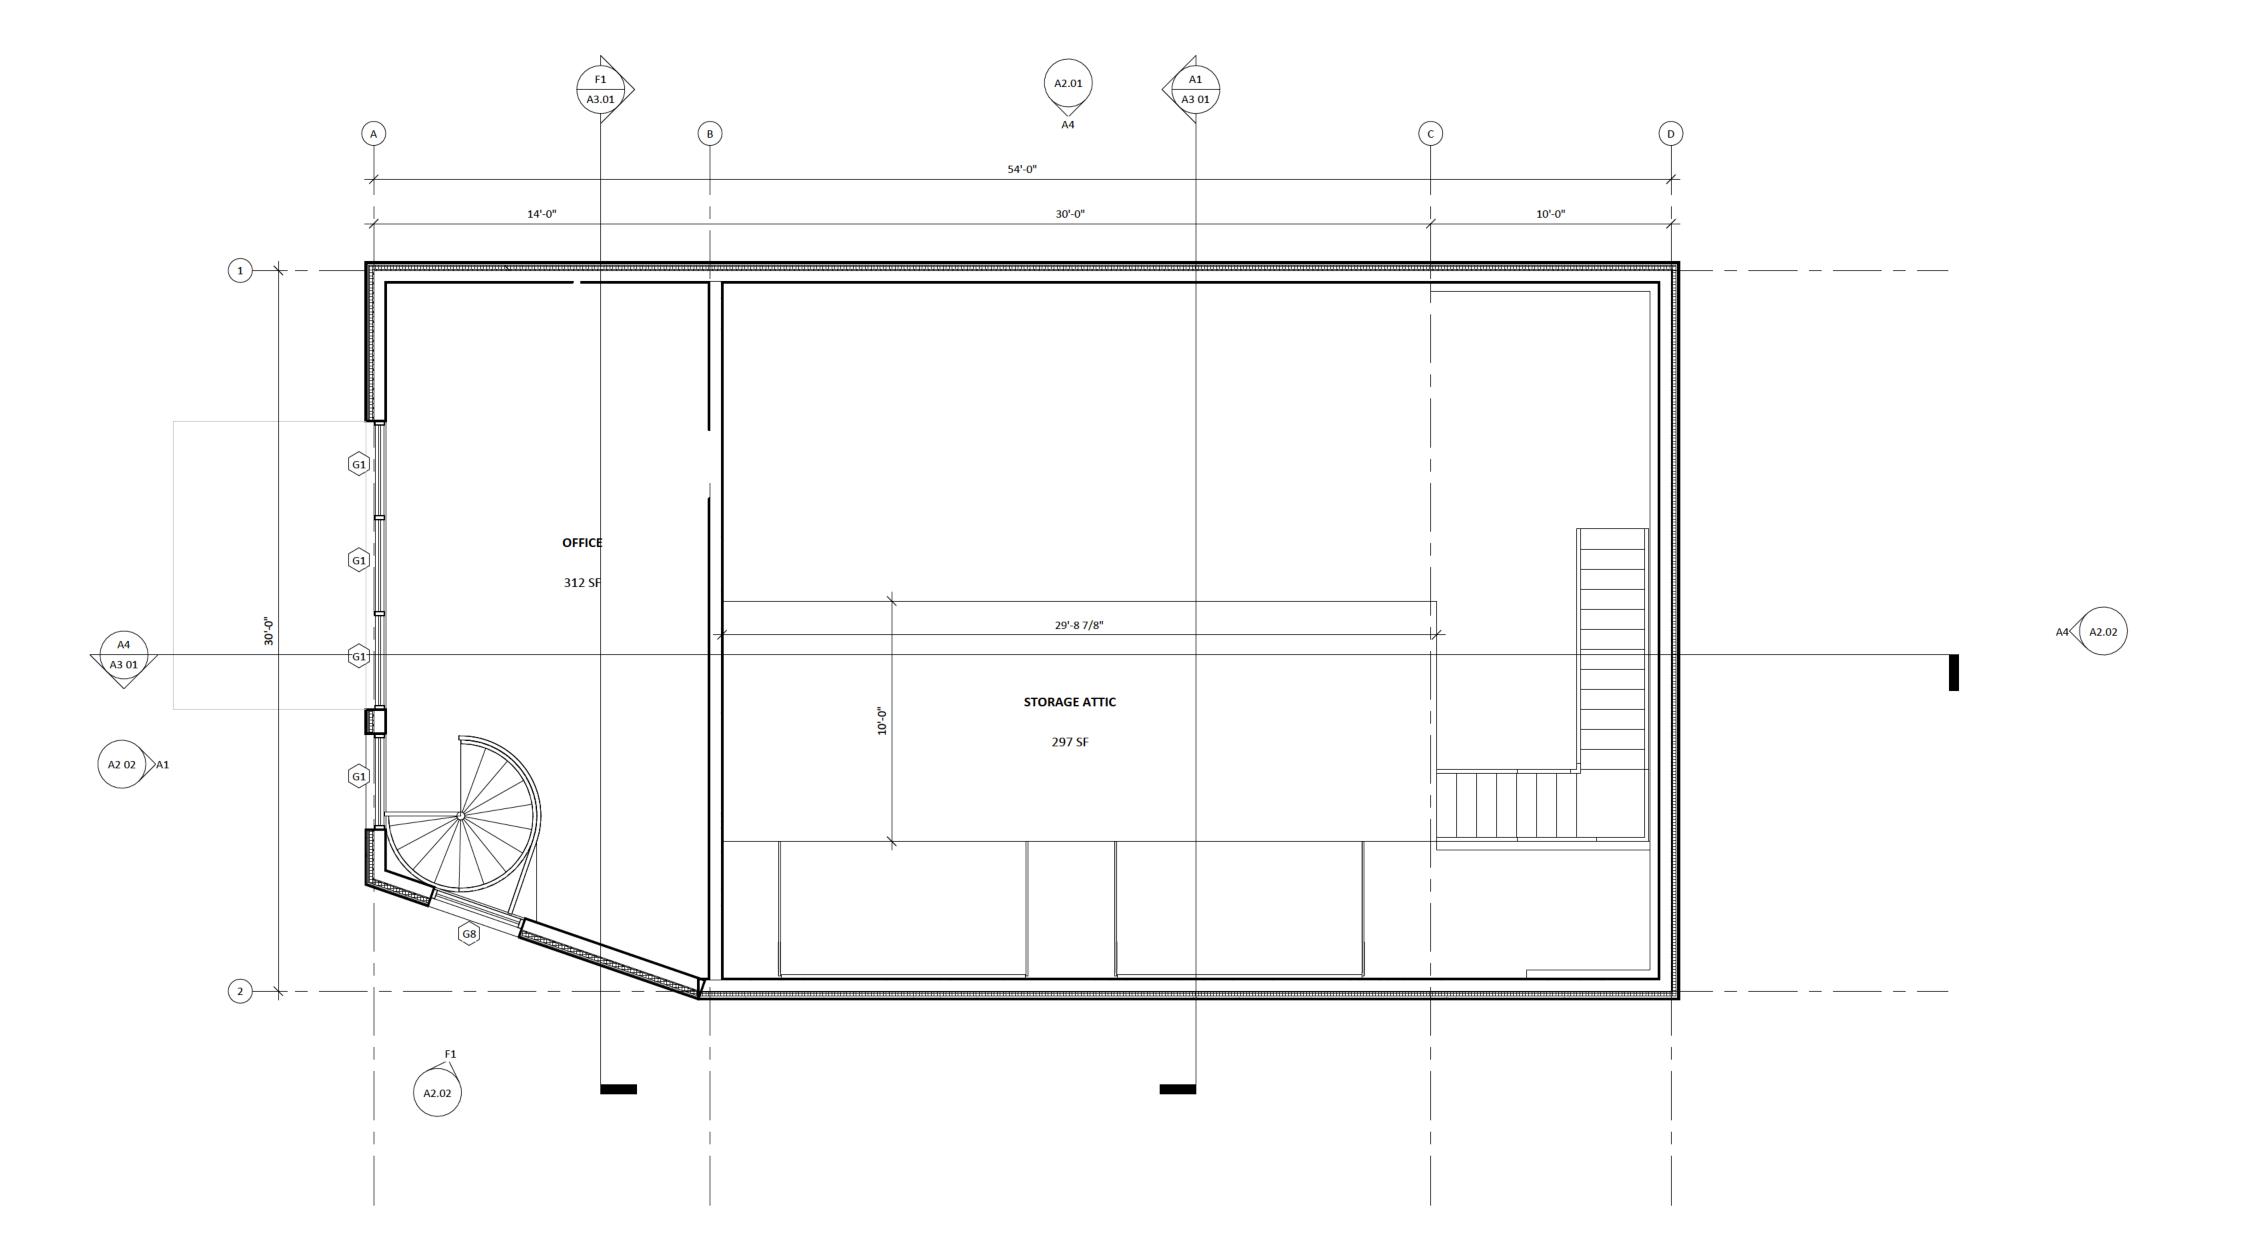

## WINDOW SCHEDULE

TAG	WIDTH	HEIGHT	MAUFACTURER	MAKE	ANGLE
G1	4'-0"	7'-0"	MARVIN	ESSENTIAL	
G2	4'-0"	2'-0"	MARVIN	ESSENTIAL	
G3	4'-0"	5'-9"	MARVIN	ESSENTIAL	
G4	4'-0"	7'-0"	MARVIN	ESSENTIAL	22.62
G5	4'-0"	1'-7"	MARVIN	ESSENTIAL	22.62
G6	4'-0"	3'-4 3/4"	MARVIN	ESSENTIAL	22.62
G7	4'-0"	3'-3 1/4"	MARVIN	ESSENTIAL	26.57
G8	4'-0"	6'-10 3/4"	MARVIN	ESSENTIAL	9.25

## DOOR SCHEDULE

TAG	WIDTH	HEIGHT
ED1	10'-0"	11'-0"
ED2	3'-0"	6'-8"
ED3	3'-8"	6'-10"
ID1	3'-0"	6'-8"
ID2	2'-4"	6'-8"
ID3	2'-6"	6'-8"

PROJECT DETAILS

PROJECT NAME: PROJECT NO:

25037

REILLY GARAGE

PROJECT ADDRESS: 1671 TAUGHANNOCK BLVD, BILL REILLY

TRUMANSBURG, NY 14886

CONSULTANT DETAILS

REVISION SCHEDULE

REVISION NO.

DRAWING DETAILS


DRAWING NAME: SECOND FLOOR PLAN

DRAWING NO:

ISSUE DATE:

ISSUE DATE


SEPTEMBER 26, 2025

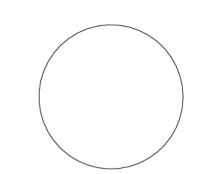

© 2013 TRADE DESIGN BUILD© 2013 TRADE DESIGN BUILD

These drawings and specifications including the design and arrangements represented herein are the property of Trade Design Build. No part thereof shall be copied, disclosed to others, or used in conjunction with any work or project other than that for which they have been prepared without the express consent of Trade Design Build.

SECOND FLOOR PLAN
1/4" = 1'-0"

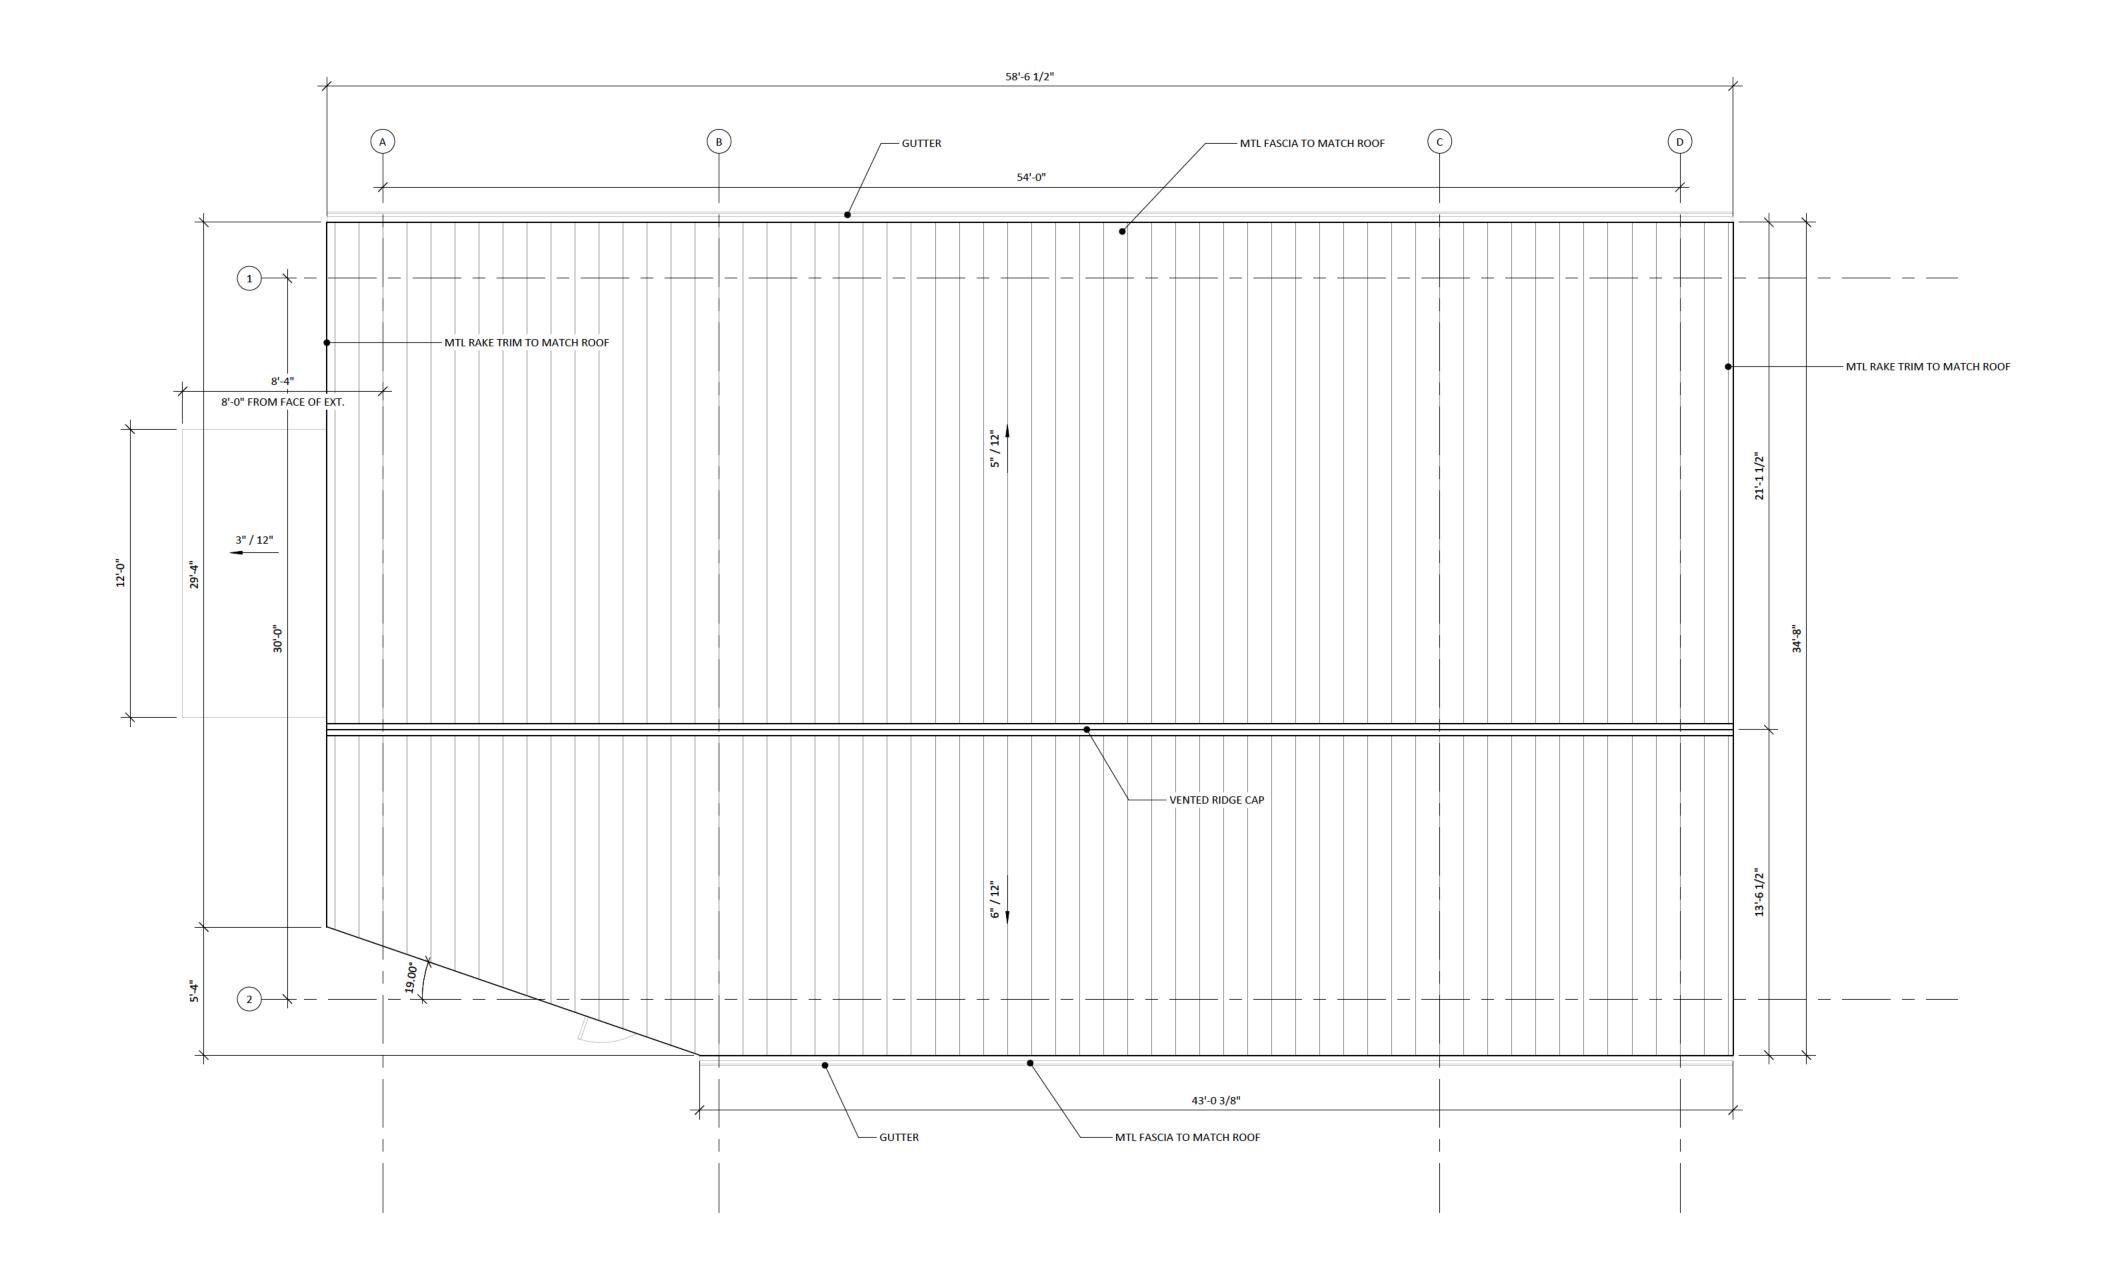

TRADE
DESIGN BUILD 1520 TRUMANSBURG ROAD ITHACA NEW YORK 14850 WWW.TRADEDESIGNBUILD.COM

PROJECT DETAILS

PROJECT NAME: REILLY GARAGE

PROJECT NO: 25037

PROJECT ADDRESS: CLIENT NAME

1671 TAUGHANNOCK BLVD, BILL REILLY

TRUMANSBURG, NY 14886

\_\_\_\_

CONSULTANT DETAILS

REVISION SCHEDULE

REVISION NO.

DRAWING DETAILS

ROOF PLAN

DRAWING NO:


A1.03

ISSUE DATE:

DRAWN BY:

ISSUE DATE


SEPTEMBER 26, 2025 JN

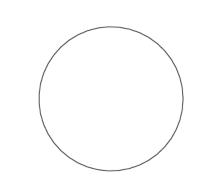

© 2013 TRADE DESIGN BUILD® 2013 TRADE DESIGN BUILD

These drawings and specifications including the design and arrangements represented herein are the property of Trade Design Build. No part thereof shall be copied, disclosed to others, or used in conjunction with any work or project other than that for which they have been prepared without the express consent of Trade Design Build.

A1 ROOF PLAN
1/4" = 1'-0"

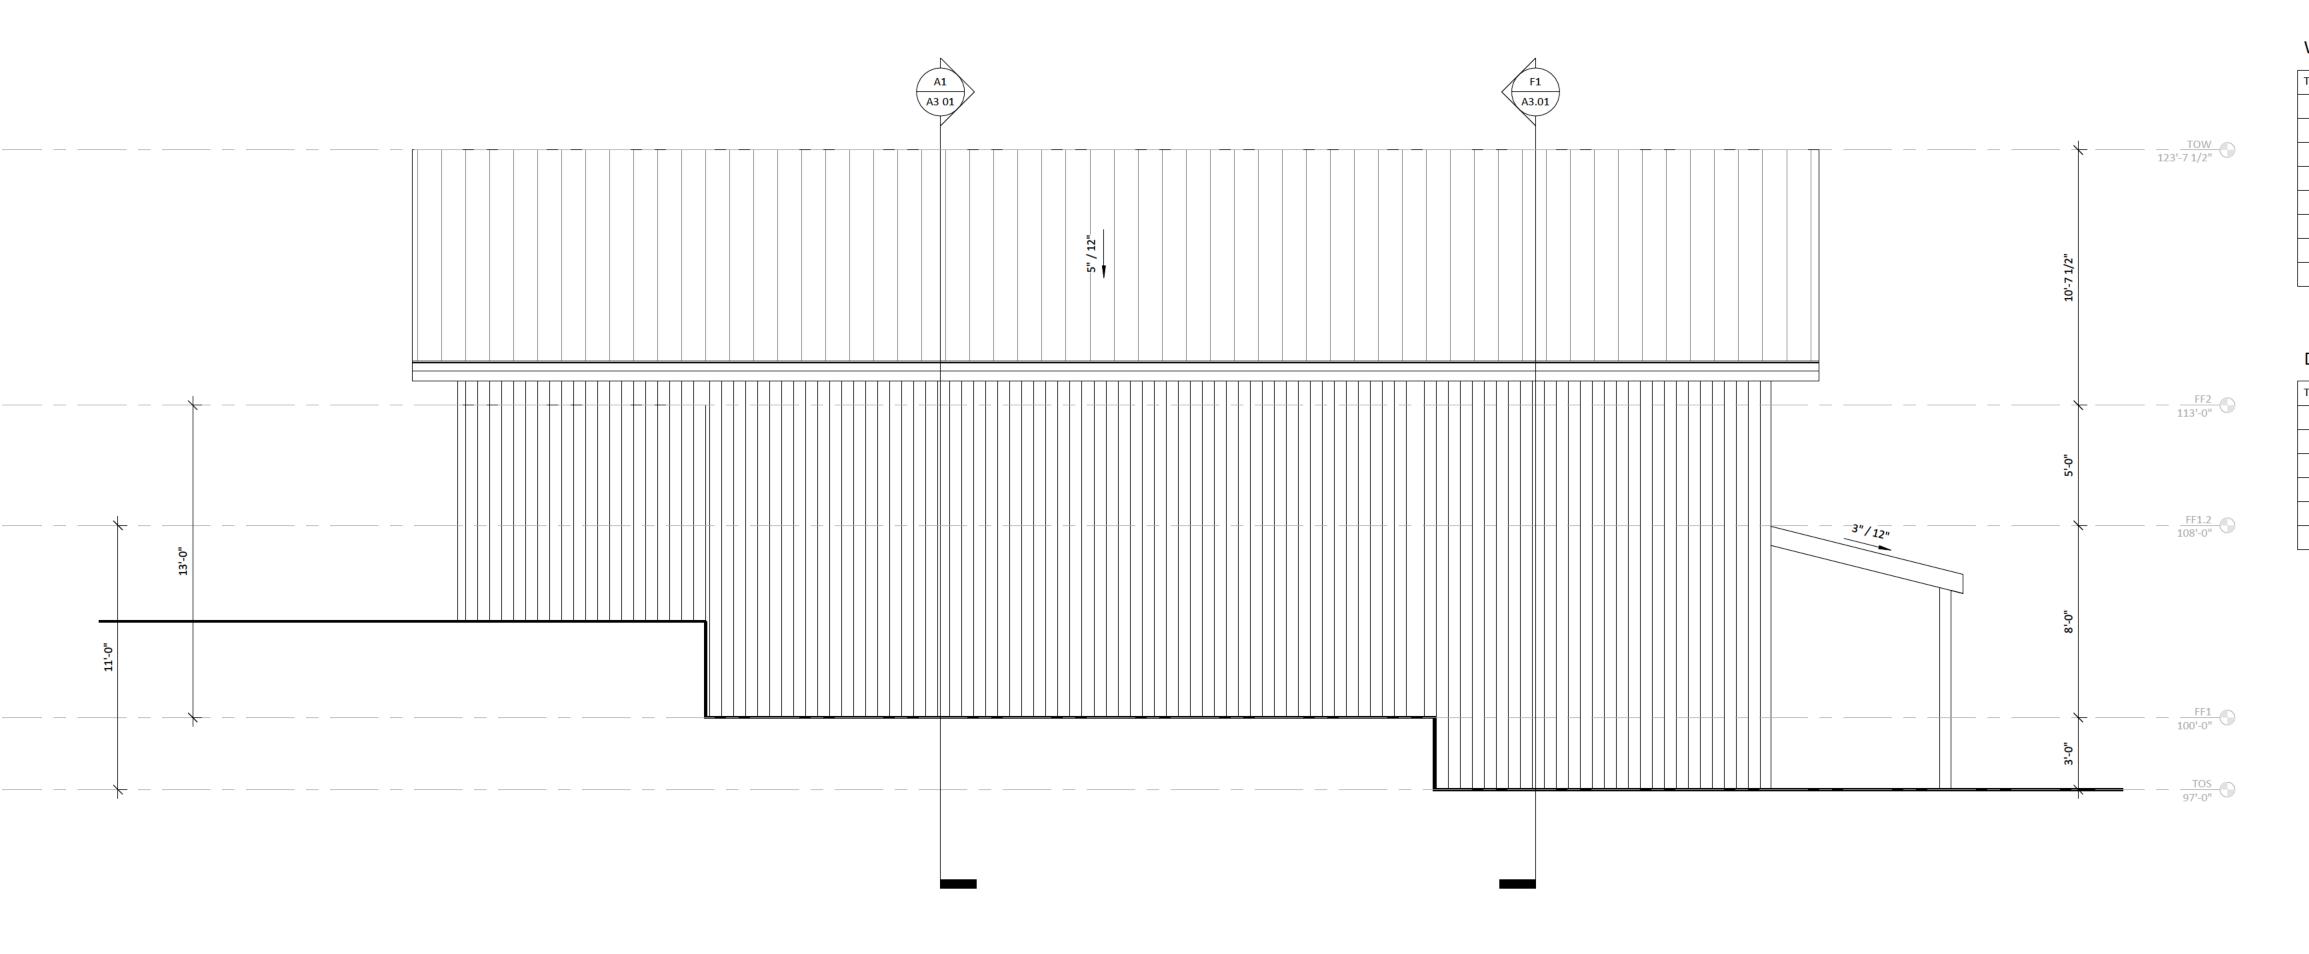

## WINDOW SCHEDULE

TAG	WIDTH	HEIGHT	MAUFACTURER	MAKE	ANGLE
G1	4'-0"	7'-0"	MARVIN	ESSENTIAL	
G2	4'-0"	2'-0"	MARVIN	ESSENTIAL	
G3	4'-0"	5'-9"	MARVIN	ESSENTIAL	
G4	4'-0"	7'-0"	MARVIN	ESSENTIAL	22.62
G5	4'-0"	1'-7"	MARVIN	ESSENTIAL	22.62
G6	4'-0"	3'-4 3/4"	MARVIN	ESSENTIAL	22.62
G7	4'-0"	3'-3 1/4"	MARVIN	ESSENTIAL	26.57
G8	4'-0"	6'-10 3/4"	MARVIN	ESSENTIAL	9 25

## DOOR SCHEDULE

TAG	WIDTH	HEIGHT
ED1	10'-0"	11'-0"
ED2	3'-0"	6'-8"
ED3	3'-8"	6'-10"
ID1	3'-0"	6'-8"
ID2	2'-4"	6'-8"
ID3	2'-6"	6'-8"

CONSULTANT DETAILS

PROJECT DETAILS

PROJECT NAME:

REILLY GARAGE

PROJECT ADDRESS:

TRUMANSBURG, NY 14886

1671 TAUGHANNOCK BLVD, BILL REILLY

TRADE
DESIGN BUILD 1520 TRUMANSBURG ROAD ITHACA NEW YORK 14850 WWW.TRADEDESIGNBUILD.COM

PROJECT NO:

25037

REVISION SCHEDULE

REVISION NO.

DRAWING DETAILS

DRAWING NAME:

**EXTERIOR ELEVATIONS** 

DRAWING NO:


A2.01


ISSUE DATE:

JN

ISSUE DATE

SEPTEMBER 26, 2025

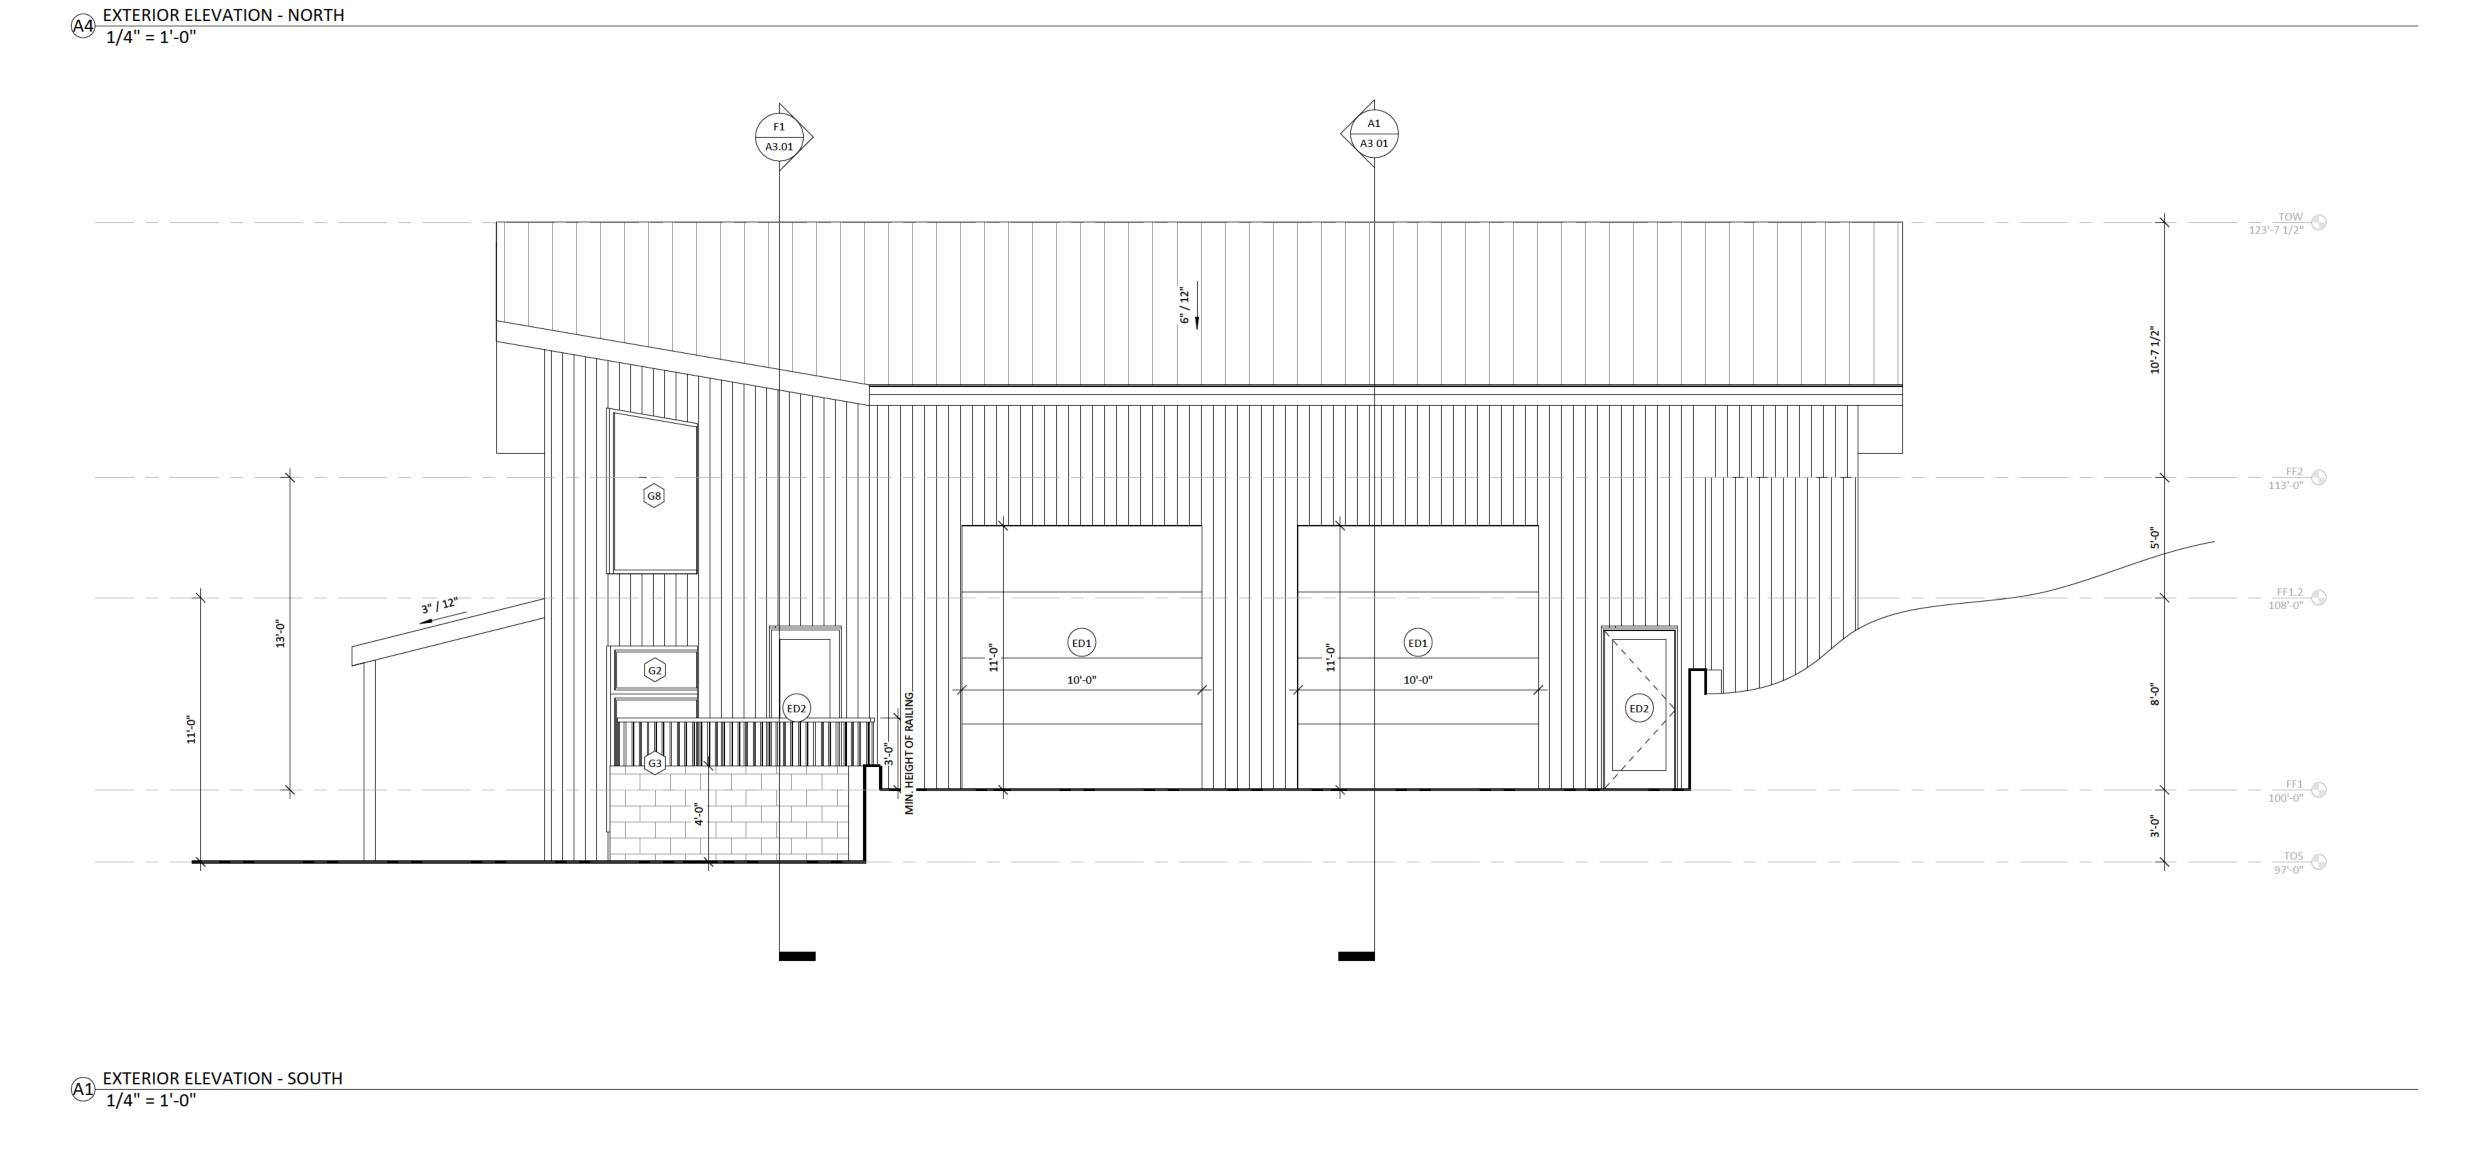

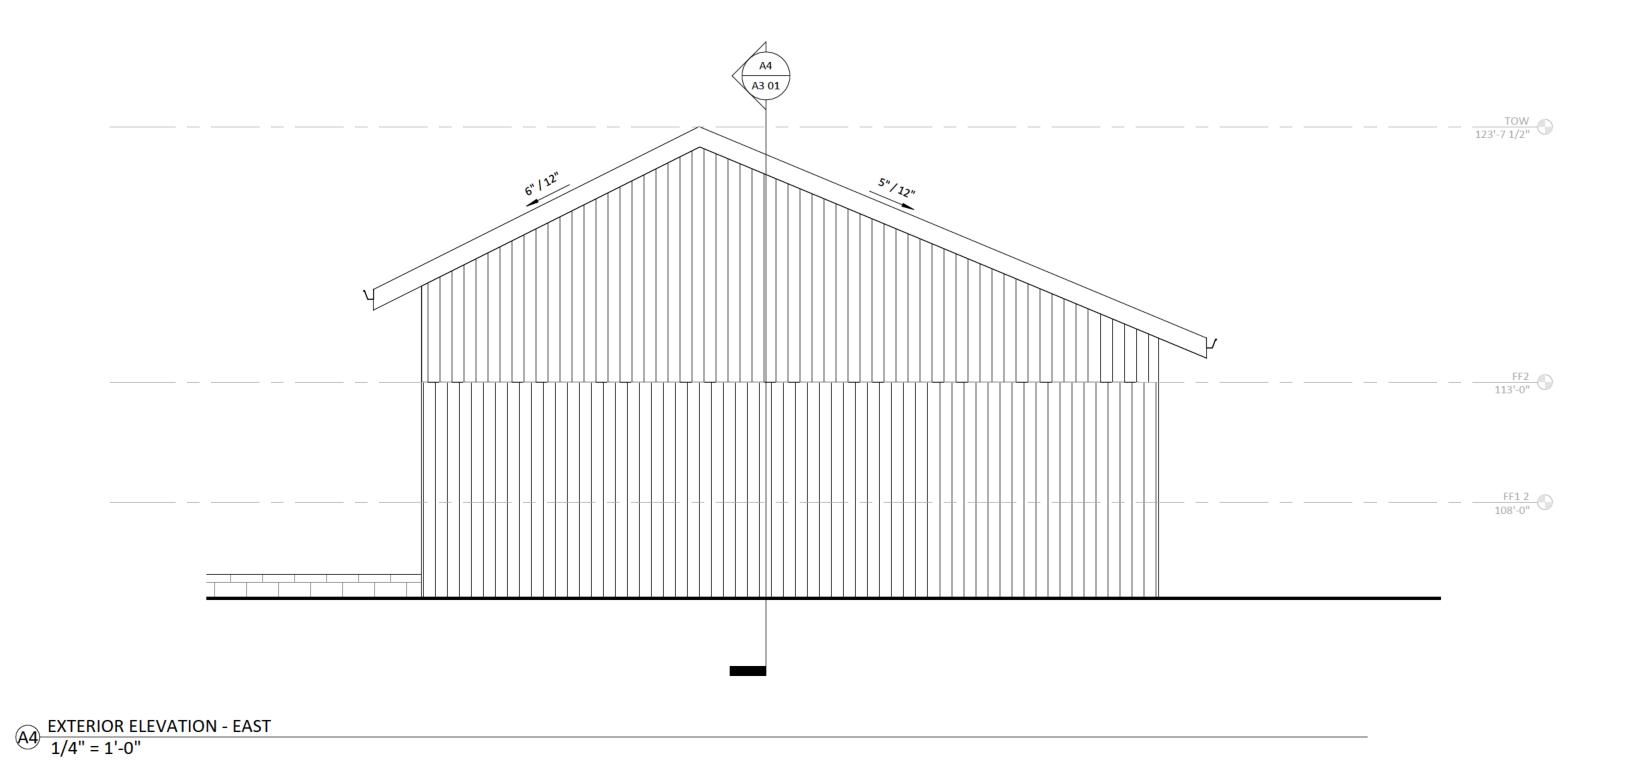

4'-0"

WINDOW PROVIDER TO ACCOUNT FOR — 2X STRUCTURE BETWEEN WINDOW UNITS

EXTERIOR ELEVATION - WEST

1/4" = 1'-0"

F1 EXTERIOR ELEVATION - NORTHWEST 1/4" = 1'-0"

## WINDOW SCHEDULE

TAG	WIDTH	HEIGHT	MAUFACTURER	MAKE	ANGLE
G1	4'-0"	7'-0"	MARVIN	ESSENTIAL	
G2	4'-0"	2'-0"	MARVIN	ESSENTIAL	
G3	4'-0"	5'-9"	MARVIN	ESSENTIAL	
G4	4'-0"	7'-0"	MARVIN	ESSENTIAL	22.62
G5	4'-0"	1'-7"	MARVIN	ESSENTIAL	22.62
G6	4'-0"	3'-4 3/4"	MARVIN	ESSENTIAL	22.62
G7	4'-0"	3'-3 1/4"	MARVIN	ESSENTIAL	26.57
G8	4'-0"	6'-10 3/4"	MARVIN	ESSENTIAL	9.25
		•			

(ED1)

## DOOR SCHEDULE

TAG	WIDTH	HEIGHT
ED1	10'-0"	11'-0"
ED2	3'-0"	6'-8"
ED3	3'-8"	6'-10"
ID1	3'-0"	6'-8"
ID2	2'-4"	6'-8"
ID3	2'-6"	6'-8"

TRADE
DESIGN BUILD 1520 TRUMANSBURG ROAD ITHACA NEW YORK 14850 WWW.TRADEDESIGNBUILD.COM

PROJECT DETAILS

PROJECT NAME: PROJECT NO:

25037

PROJECT ADDRESS: CLIENT NAM

1671 TAUGHANNOCK BLVD,
TRUMANSBURG, NY 14886

REILLY GARAGE

CONSULTANT DETAILS

REVISION SCHEDULE

REVISION NO.

DRAWING DETAILS

DRAWING NAME:

EXTERIOR ELEVATIONS

DRAWING NO:


A2.02

ISSUE DATE:

DRAW


ISSUE DATE


SEPTEMBER 26, 2025

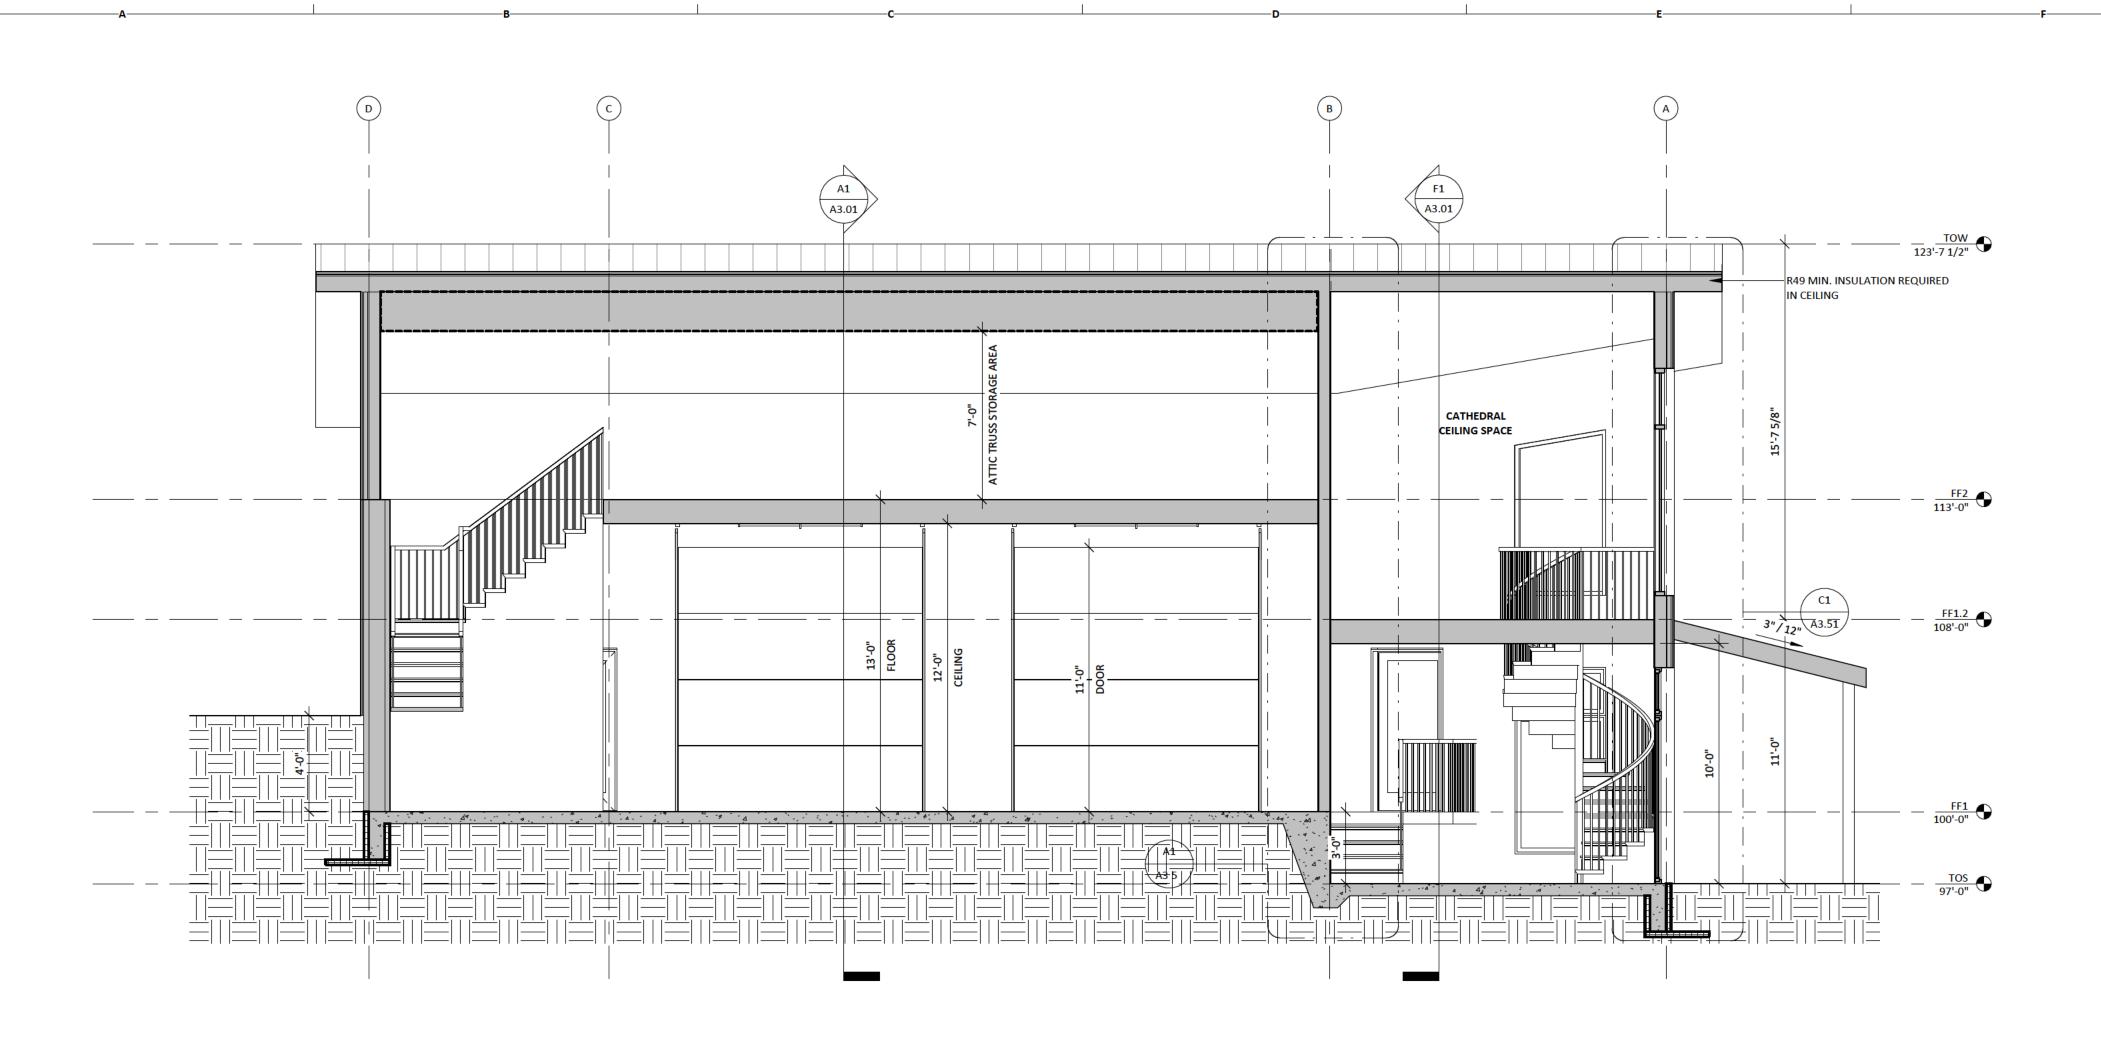

BUILDING SECTION - NORTH

1/4" = 1'-0"

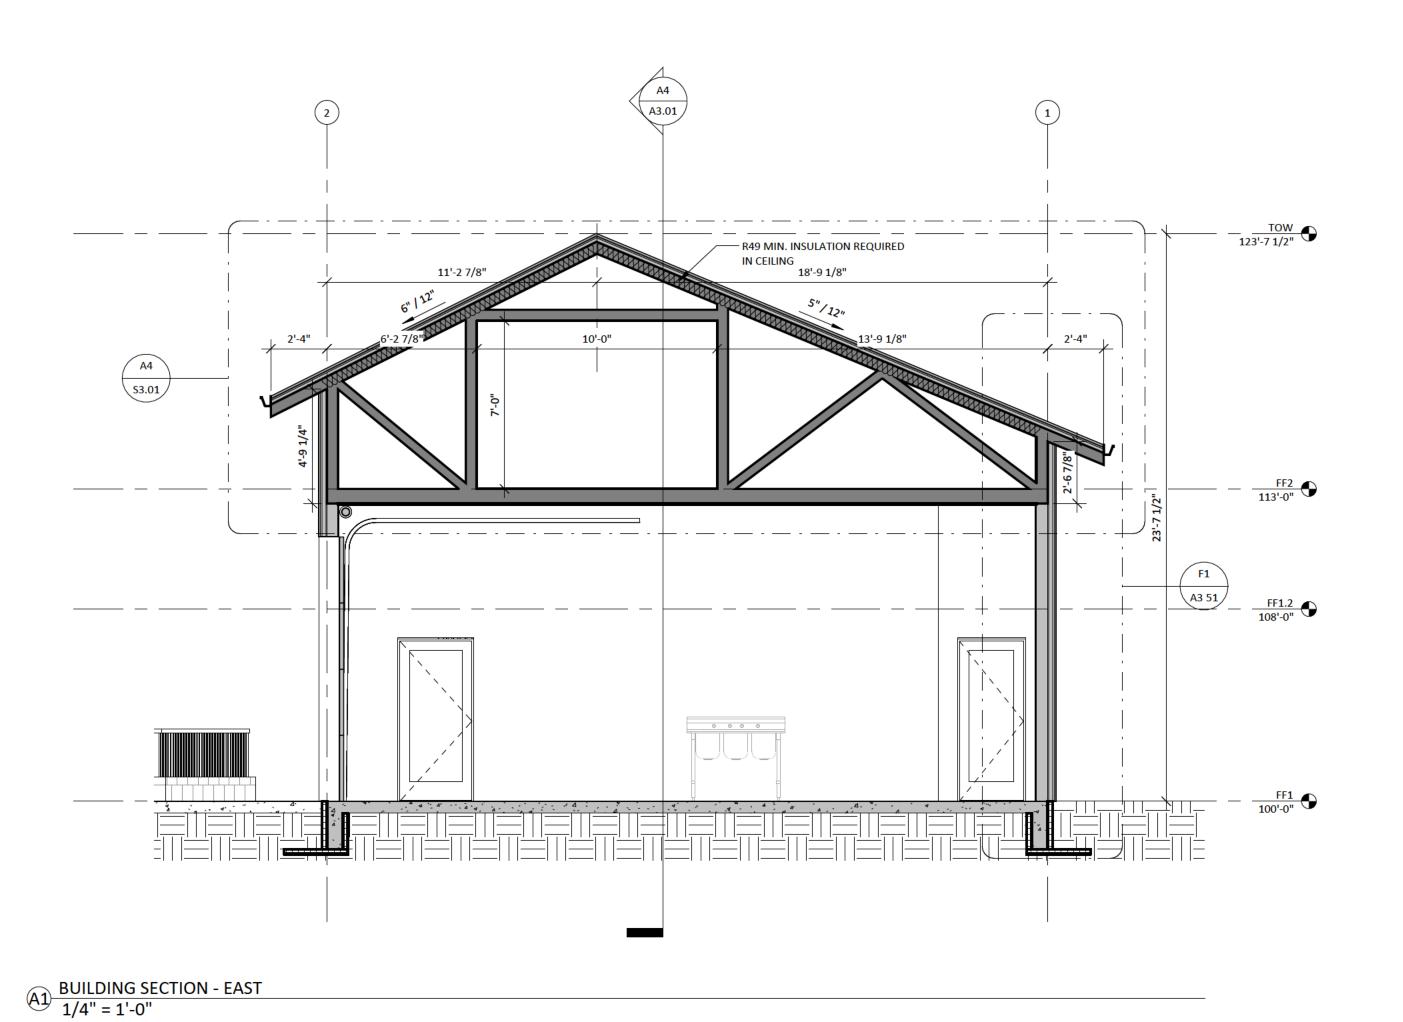

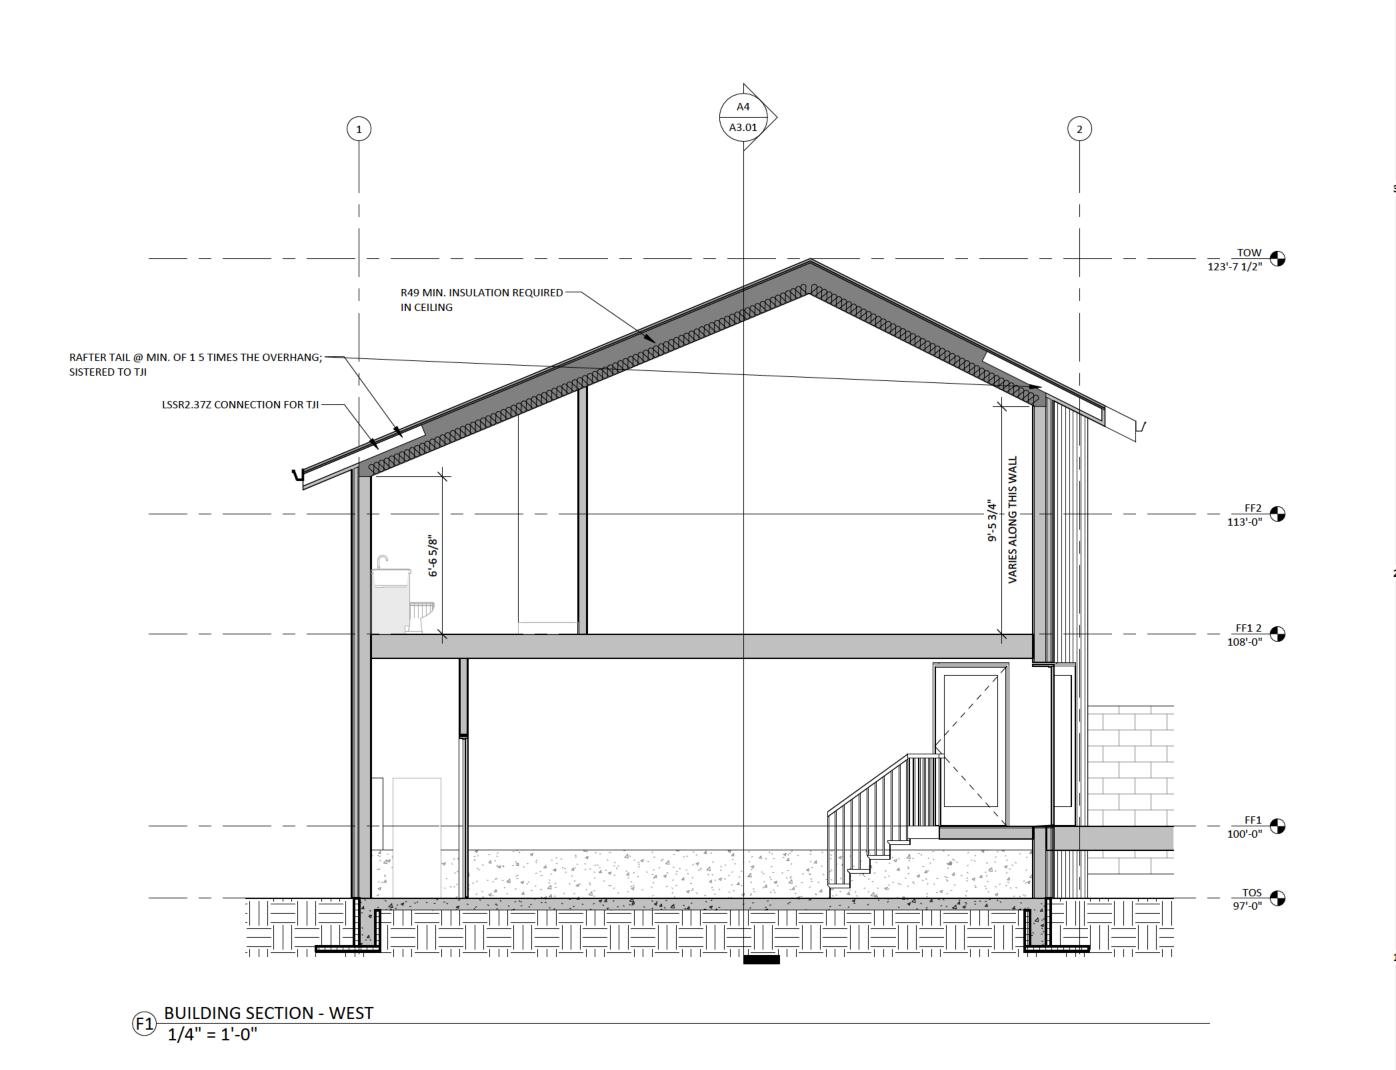

TRADE
DESIGN BUILD 1520 TRUMANSBURG ROAD 171HACA NEW YORK 14850 WWW.TRADEDESIGNBUILD.COM

PROJECT NO:

PROJECT DETAILS

PROJECT NAME: REILLY GARAGE

PROJECT ADDRESS:

1671 TAUGHANNOCK BLVD, BILL REILLY TRUMANSBURG, NY 14886

CONSULTANT DETAILS

REVISION SCHEDULE

REVISION NO.

DRAWING DETAILS

DRAWING NAME:

**BUILDING SECTIONS** 

DRAWING NO:


A3.01


ISSUE DATE: SEPTEMBER 26, 2025

DRAWN B

ISSUE DATE

26, 2025

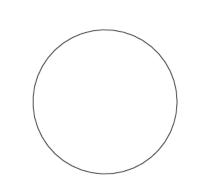

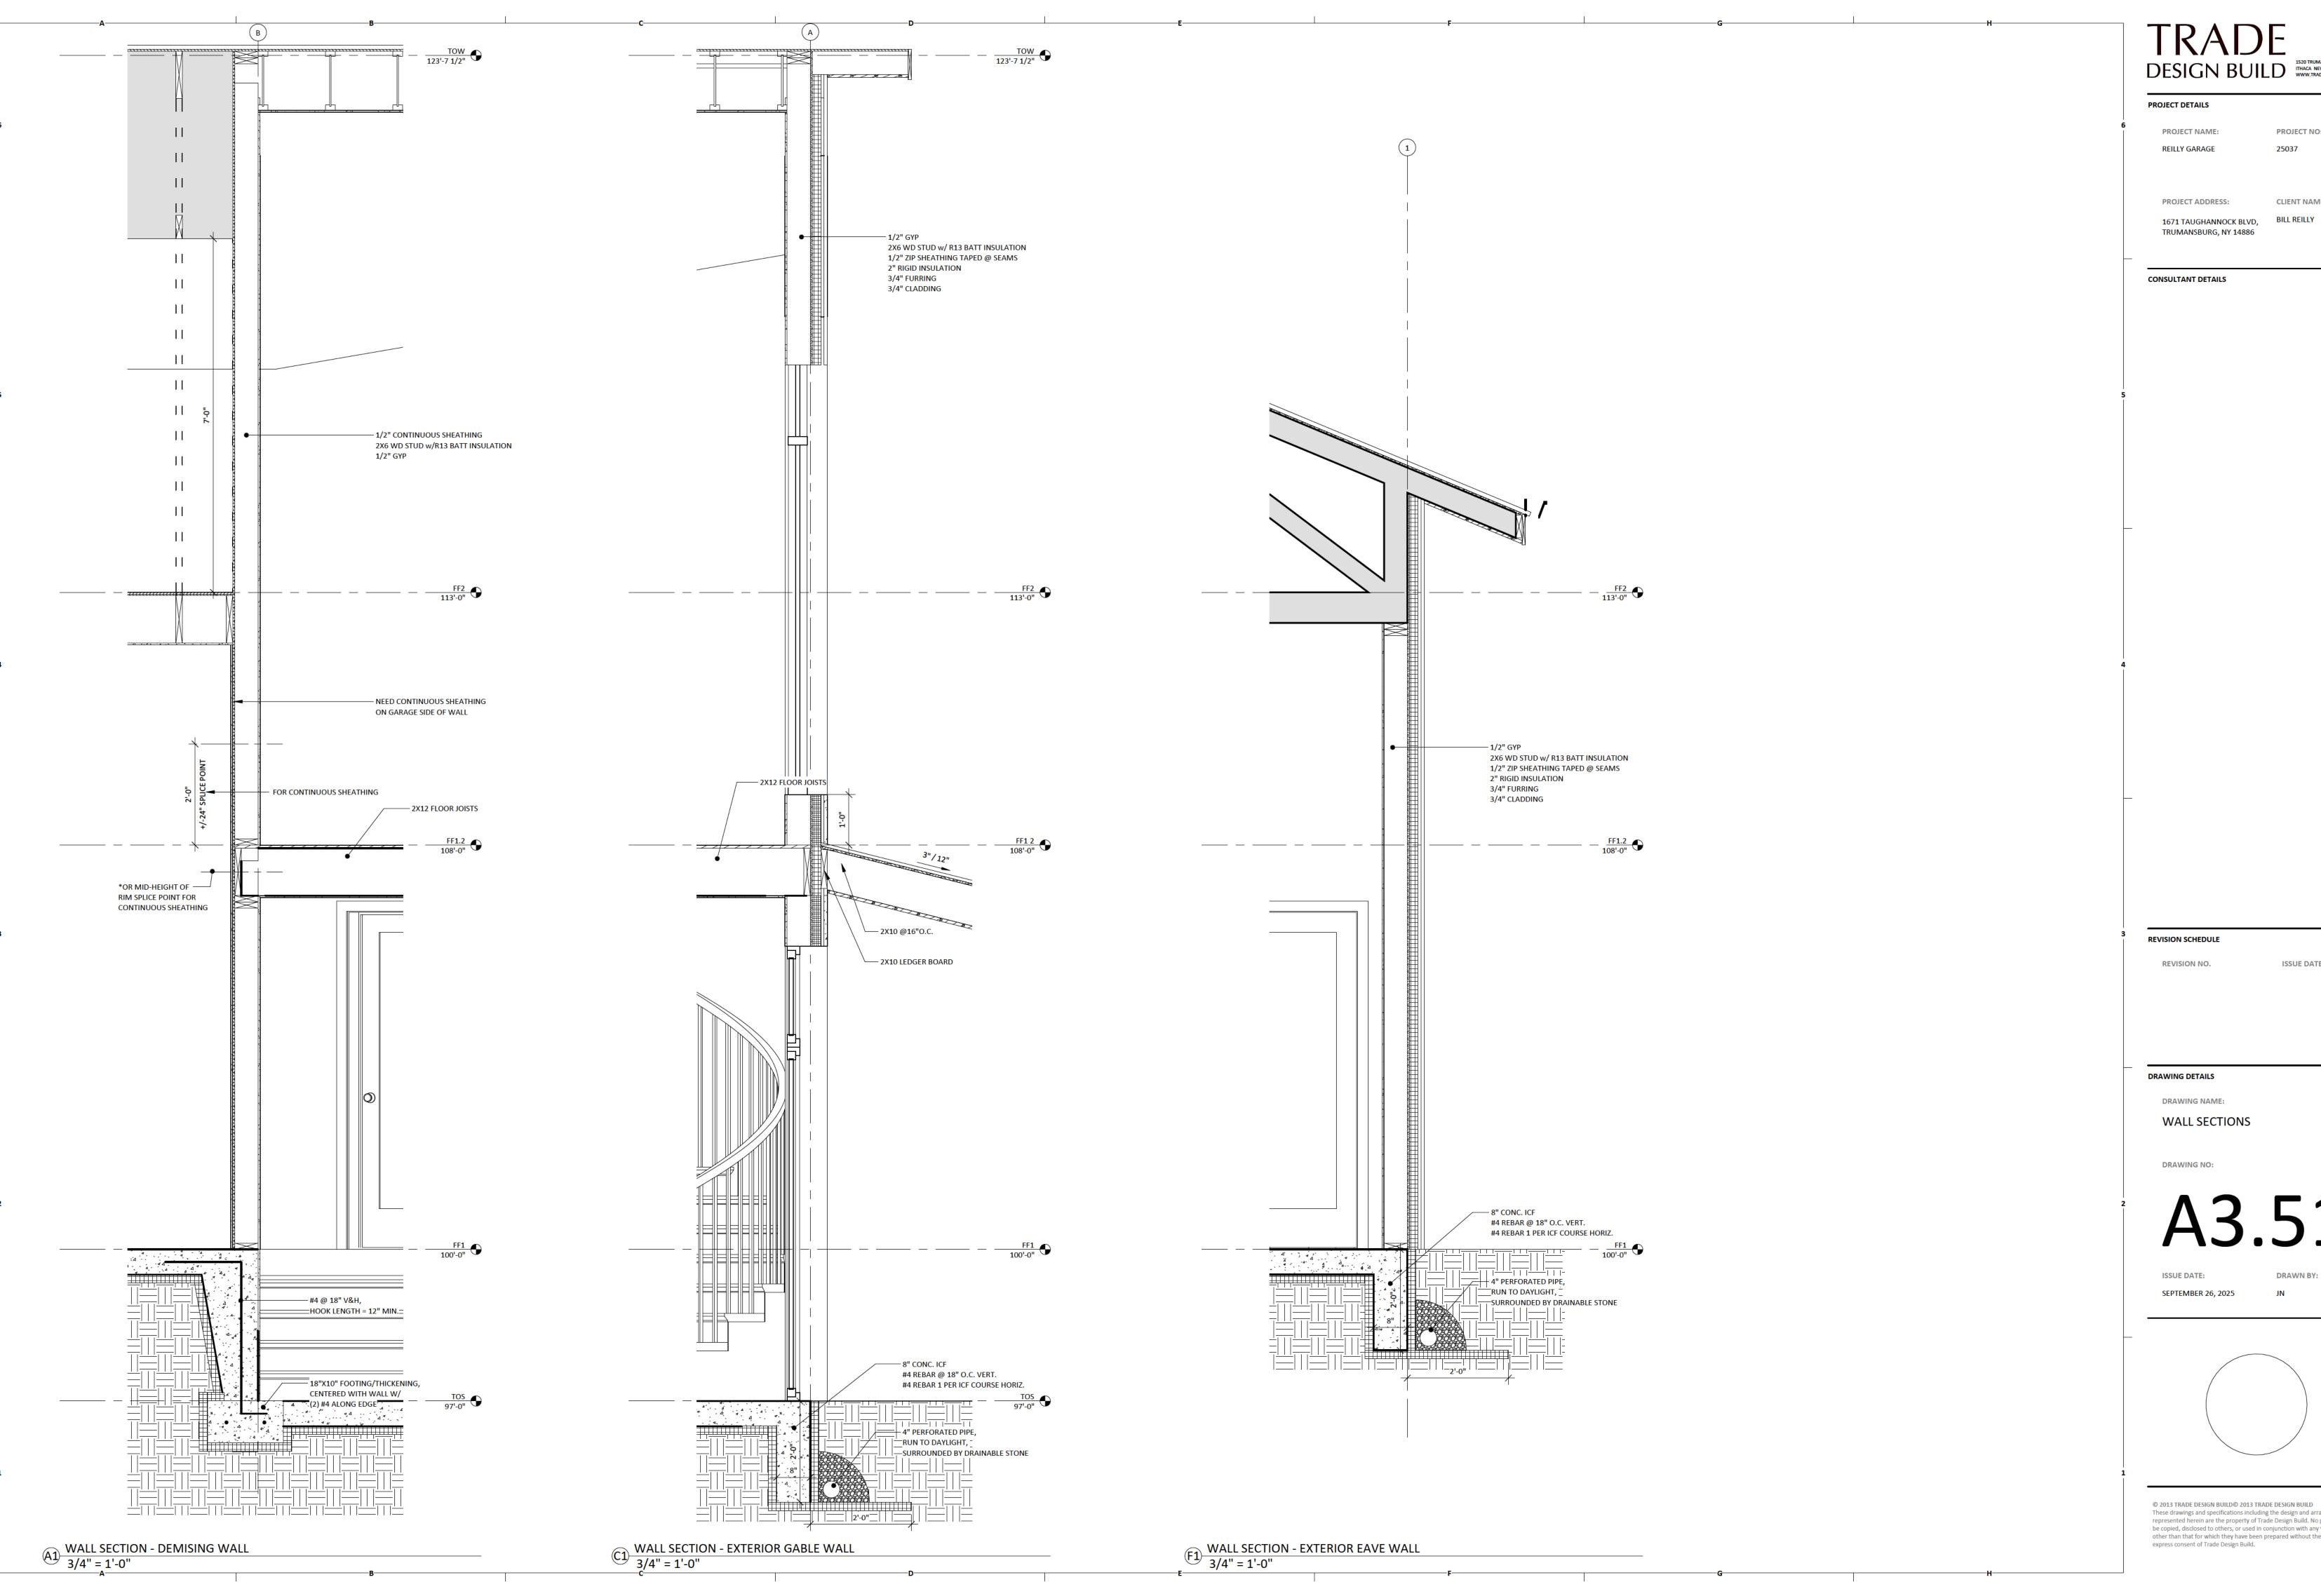

PROJECT NO:

25037

REILLY GARAGE

PROJECT ADDRESS:

CONSULTANT DETAILS

REVISION SCHEDULE

REVISION NO.

DRAWING NAME:

ISSUE DATE

