

ADDRESS PARCEL NO(S)

SKETCH SITE PLAN APPLICATION

PLANNING AND ZONING DEPARTMENT

INSTRUCTIONS: Complete form, sign, and date. See applicable application packet for all required checklist items.

CONTACTINFORMATION					
APPLICANT	TRADE Design Build- Craig Modisher- Project Manager				
ADDRESS	1520 Trumansburg Road				
CITY	Ithaca	STATE	NY	ZIP	14850
PHONE	607-351-1915 EMAIL craig@tradedesignbuild.com			.com	
OWNER	Peter and Ursula Brownin	ng			
ADDRESS	111 Cottage Place				
CITY	Ithaca	STATE	NY	ZIP	14850
PHONE	607-592-2576	EMAIL	PETERVBROWNING@gm	ail.d	com
PRIMARY CONTACT ☑APPLICANT ☐OWNER ☐OTHER, PLEASE SPECIFY BELOW					
NAME					
PHONE		EMAIL			
PROJECT SITE INFORMATION					

PROJECT INFORMATION		
PROJECT NAME	33 Maplewood Road	
PROJECT DESCRIPTION	The complete renovation of the building into a 3 story home, built on the existing foundation and first floor walls. Some minor reenforcement of an existing retaining wall along the creek, and a replacement of the existing septic system.	
VALUATION		

Authorization: I am the owner or am authorized by the owner to sign and submit this application. I certify under penalty						
of perjury of the laws of the State of New York that the information on this application and all information submitted						
herewith is true, c	herewith is true, complete, and correct.					
SIGNATURE		or but	DATE 10/30/2025			
PRINT NAME Craig Modisher						
CITY, STATE Ithaca NY						

607.387.5767



33 Maplewood Road

29-1-28



UPDATED 2025



October 30, 2025

Browning Lake House 33 Maplewood Road Ulysses NY

Project Narrative

The proposed project for this site is a complete renovation of the existing building, a new wastewater treatment system, and minor reinforcement of an existing retaining wall along the creek.

The original building was a single story concrete structure. Then a wood framed second floor was built on top of the concrete roof, with attic trusses creating usable space on the third floor. We are proposing to demo the building down to the first floor concrete walls, and then build back up with wood framing.

The existing "septic system" is a CMU pit in the ground. We are working with Tompkins County Health to provide a substantial improvement for the on-site wastewater system, despite the challenging location.

The existing retaining wall along the creek is starting to flake off and degrade. We are proposing to reinforce the existing wall with a 4" wrap of steel reinforced concrete as a minimal, but effective solution. We have already reached out to the DEC, and are awaiting a letter of "no jurisdiction".



November 3, 2025

Niels Tygesen
Planner
Town of Ulysses
Building, Code, Planning & Zoning Department
10 Elm Street
Trumansburg, NY 14886

RE: Sketch Plan Review – Peter and Ursula Browning


Browning Lake House 33 Maplewood Road Town of Ulysses, NY

Dear Niels,

I am working as a sub-consultant to Trade Design Build on an application for a project at 33 Maplewood Road. The project includes the renovation of the building into a 3 story home, minor reinforcement of an existing concrete retaining wall along the stream, and replacement of the existing septic system. My scope includes applying for permits required for the reinforcement of the stream wall, the design of a new septic system, and designing temporary erosion controls and drainage systems for the project.

Stream Wall Reinforcement

The reinforcement of the stream wall is envisioned as a 4" thick reinforced concrete wrap (or inverted "U") and will not impact the stream. See sketch below. We understand this work may be regulated by the Town and/or the NYSDEC. The stream is not a NYSDEC classified stream per online mapping and as such, we have requested a determination of no jurisdiction from Melanie Kukko, Environmental Analyst, in the NYSDEC Division of Environmental Permits. If the stream is jurisdictional we will apply for and obtain all requisite NYSDEC permits.

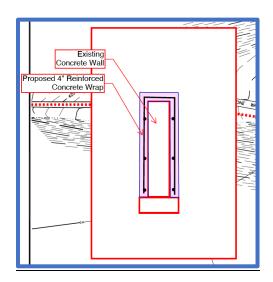



Septic System

The existing septic system appears to consist of a septic tank and buried cistern (or cess-pool). The system is functioning and Tompkins County Whole Health (TCWH) has indicated the system can remain as no new bedrooms are proposed as part of the renovations. However, the Browning's wish to install a replacement system to bring the system up to current NYSDOH and County standards. We will be applying to the TCWH this month and anticipate having approval for the replacement system before the end of the year.


Stormwater and Erosion Controls


Runoff from the roof and concrete patio west of the building is currently collected and piped to the stream. Runoff from the patios north, south and east of the building drain across the lawn areas then to the lake. These drainage patterns will not change as a result of the renovations and the project will not create new impervious surfaces, so a stormwater mitigation plan has not been prepared. During construction, silt logs will be installed in the lawn areas east of the building to prevent sediments from entering the lake. An erosion and sediment control plan will be submitted as part of a future submission.

We look forward to presenting the project to the Planning Board on behalf of Peter and Ursula in December.

Sincerely.

Andrew J. Sciarabba, P.E. Owner/Principal Engineer

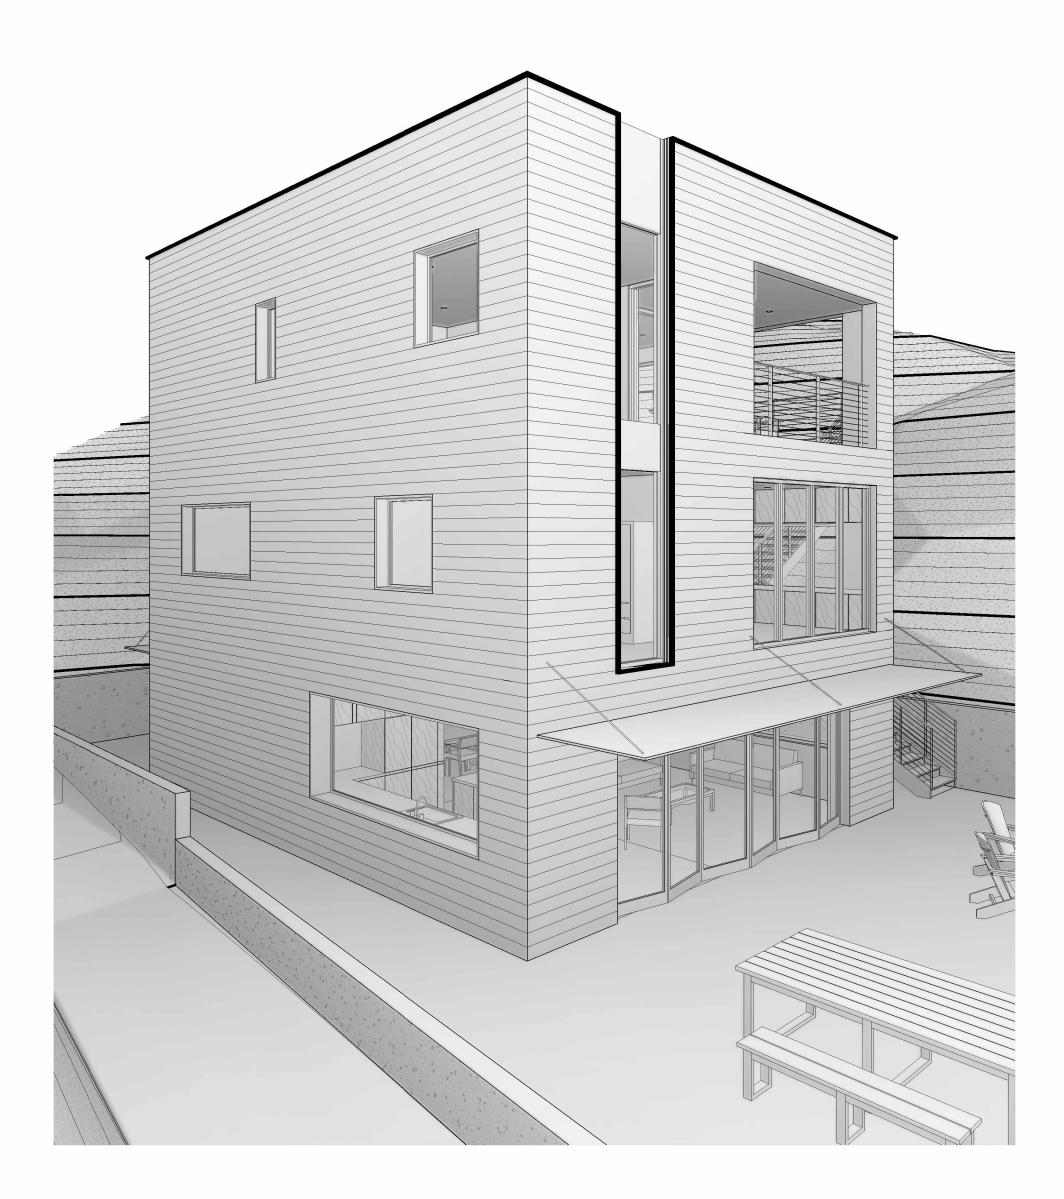

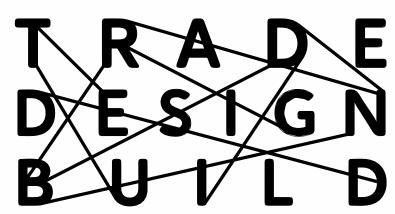

BROWNING MAPLEWOOD

33 MAPLEWOOD RD, ITHACA, NY 14850 PETER & URSULA BROWNING 25008

DRAWING LIST

AD1.00 BUILDING TAKEOFF

AD1.01 CASEWORK TAKEOFF

G0.00 COVER SHEET

G0.01 SITE PLAN & PROJECT INFO

G1.01 FIRST FLOOR PLAN

G1.02 SECOND FLOOR PLAN G1.03 THIRD FLOOR PLAN

S1.00 FOUNDATION PLAN \$1.01 FIRST FLOOR FRAMING PLAN

S1.02 SECOND FLOOR FRAMING PLAN

S1.03 ROOF FRAMING PLAN D1.01 FIRST FLOOR DEMOLITION PLAN

D1.02 SECOND FLOOR DEMOLITION PLAN

A1.01 FIRST FLOOR PLAN

A1.02 SECOND FLOOR PLAN

A1.03 THIRD FLOOR PLAN A2.01 EXTERIOR ELEVATIONS

A2.51 INTERIOR ELEVATIONS

A3.01 BUILDING SECTIONS

A3.51 WALL SECTIONS

A4.01 ENLARGED PLANS, SECTIONS AND ELEVATIONS

A5.01 EXTERIOR DETAILS

A5.51 INTERIOR DETAILS A1.04 ROOF PLAN

M1.01 FIRST FLOOR MEP PLAN

M1.02 SECOND FLOOR MEP PLAN

M1.03 THIRD FLOOR MEP PLAN M1.51 FIRST FLOOR LIGHTING PLAN

M1.52 SECOND FLOOR LIGHTING PLAN M1.53 THIRD FLOOR LIGHTING PLAN

PROJECT DETAILS

PROJECT NAME:

BROWNING MAPLEWOOD

BROWNING

CLIENT NAME: PROJECT ADDRESS: PETER & URSULA 33 MAPLEWOOD RD,

CONSULTANT DETAILS

ITHACA, NY 14850

REVISION SCHEDULE

REVISION NO.

ISSUE DATE


DRAWING DETAILS

DRAWING NAME: **COVER SHEET**

DRAWING NO:

ISSUE DATE:

SEPTEMBER 19, 2025

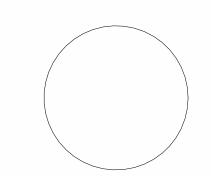


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represented herein are the property of Trade Design Build. No part thereof shall be copied, disclosed to others, or used in conjunction with any work or project





PROJECT NAME:

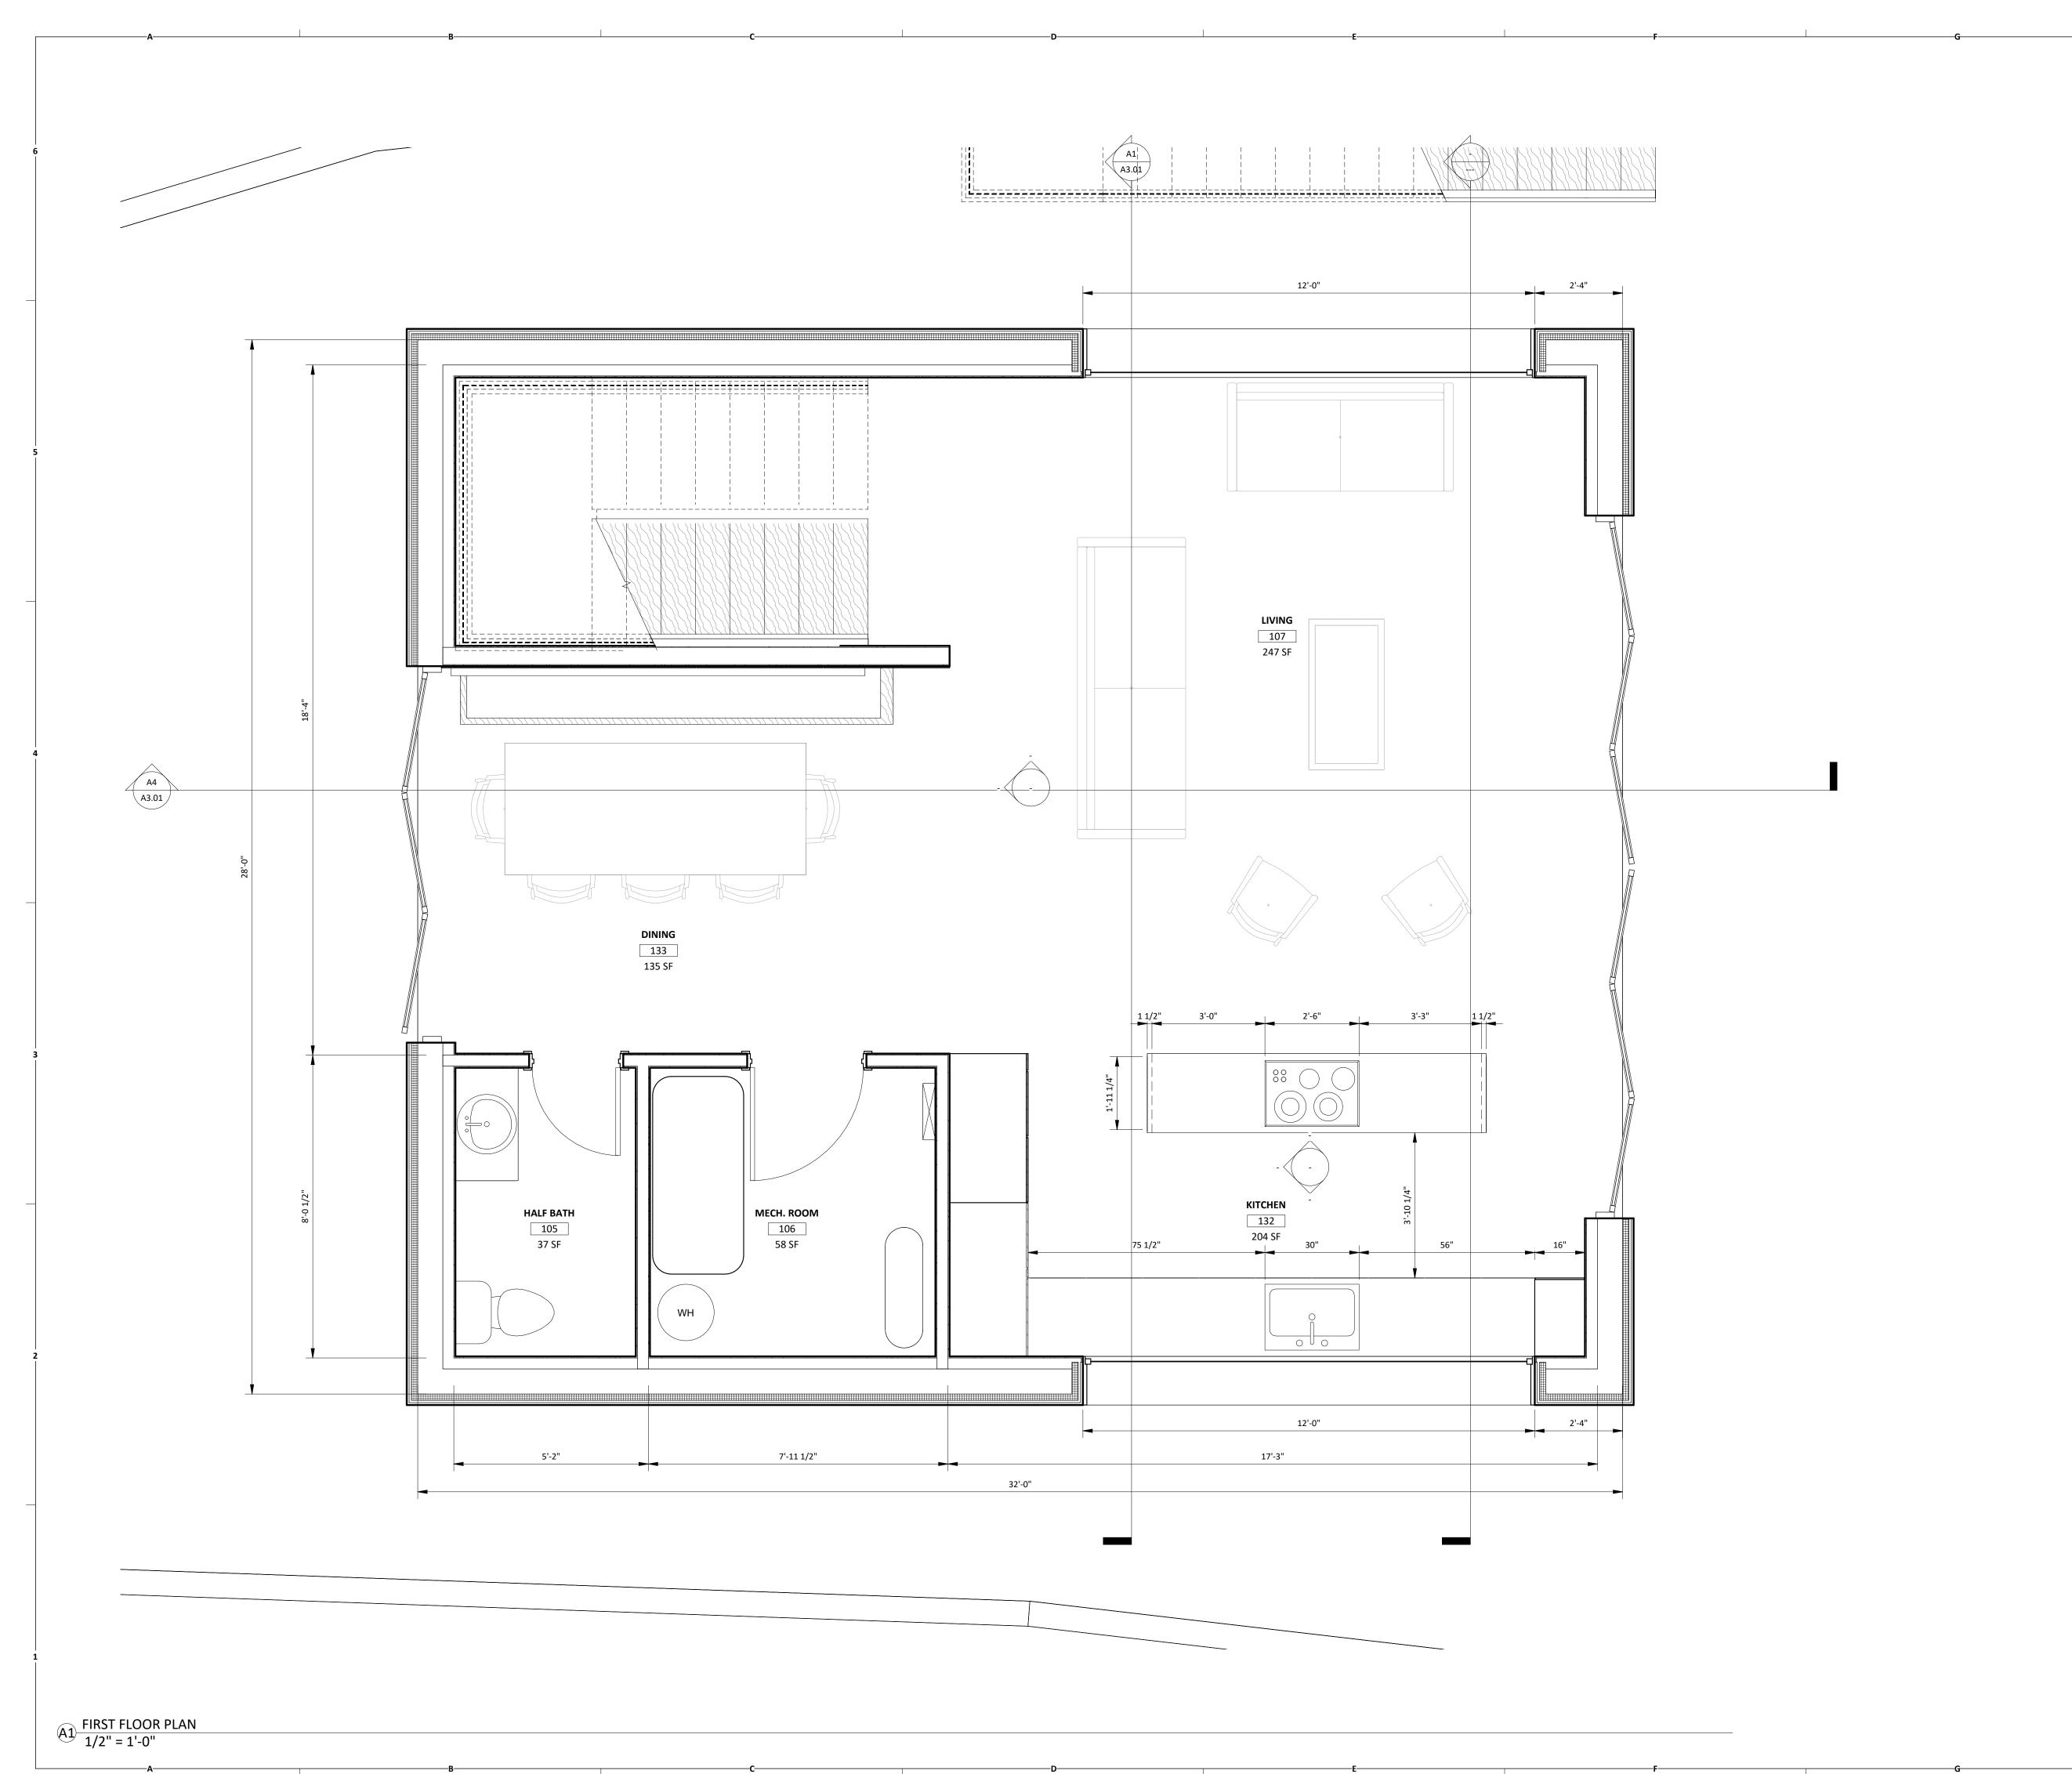BROWNING MAPLEWOOD 25008

PROJECT ADDRESS: **CLIENT NAME:**

PETER & URSULA 33 MAPLEWOOD RD, BROWNING ITHACA, NY 14850

CONSULTANT DETAILS

REVISION SCHEDULE

REVISION NO.

DRAWING DETAILS

DRAWING NAME:

DRAWING NO:

FIRST FLOOR PLAN

SEPTEMBER 19, 2025


ISSUE DATE:


DRAWN BY:

ISSUE DATE

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PROJECT NAME:

PROJECT NO: BROWNING MAPLEWOOD 25008

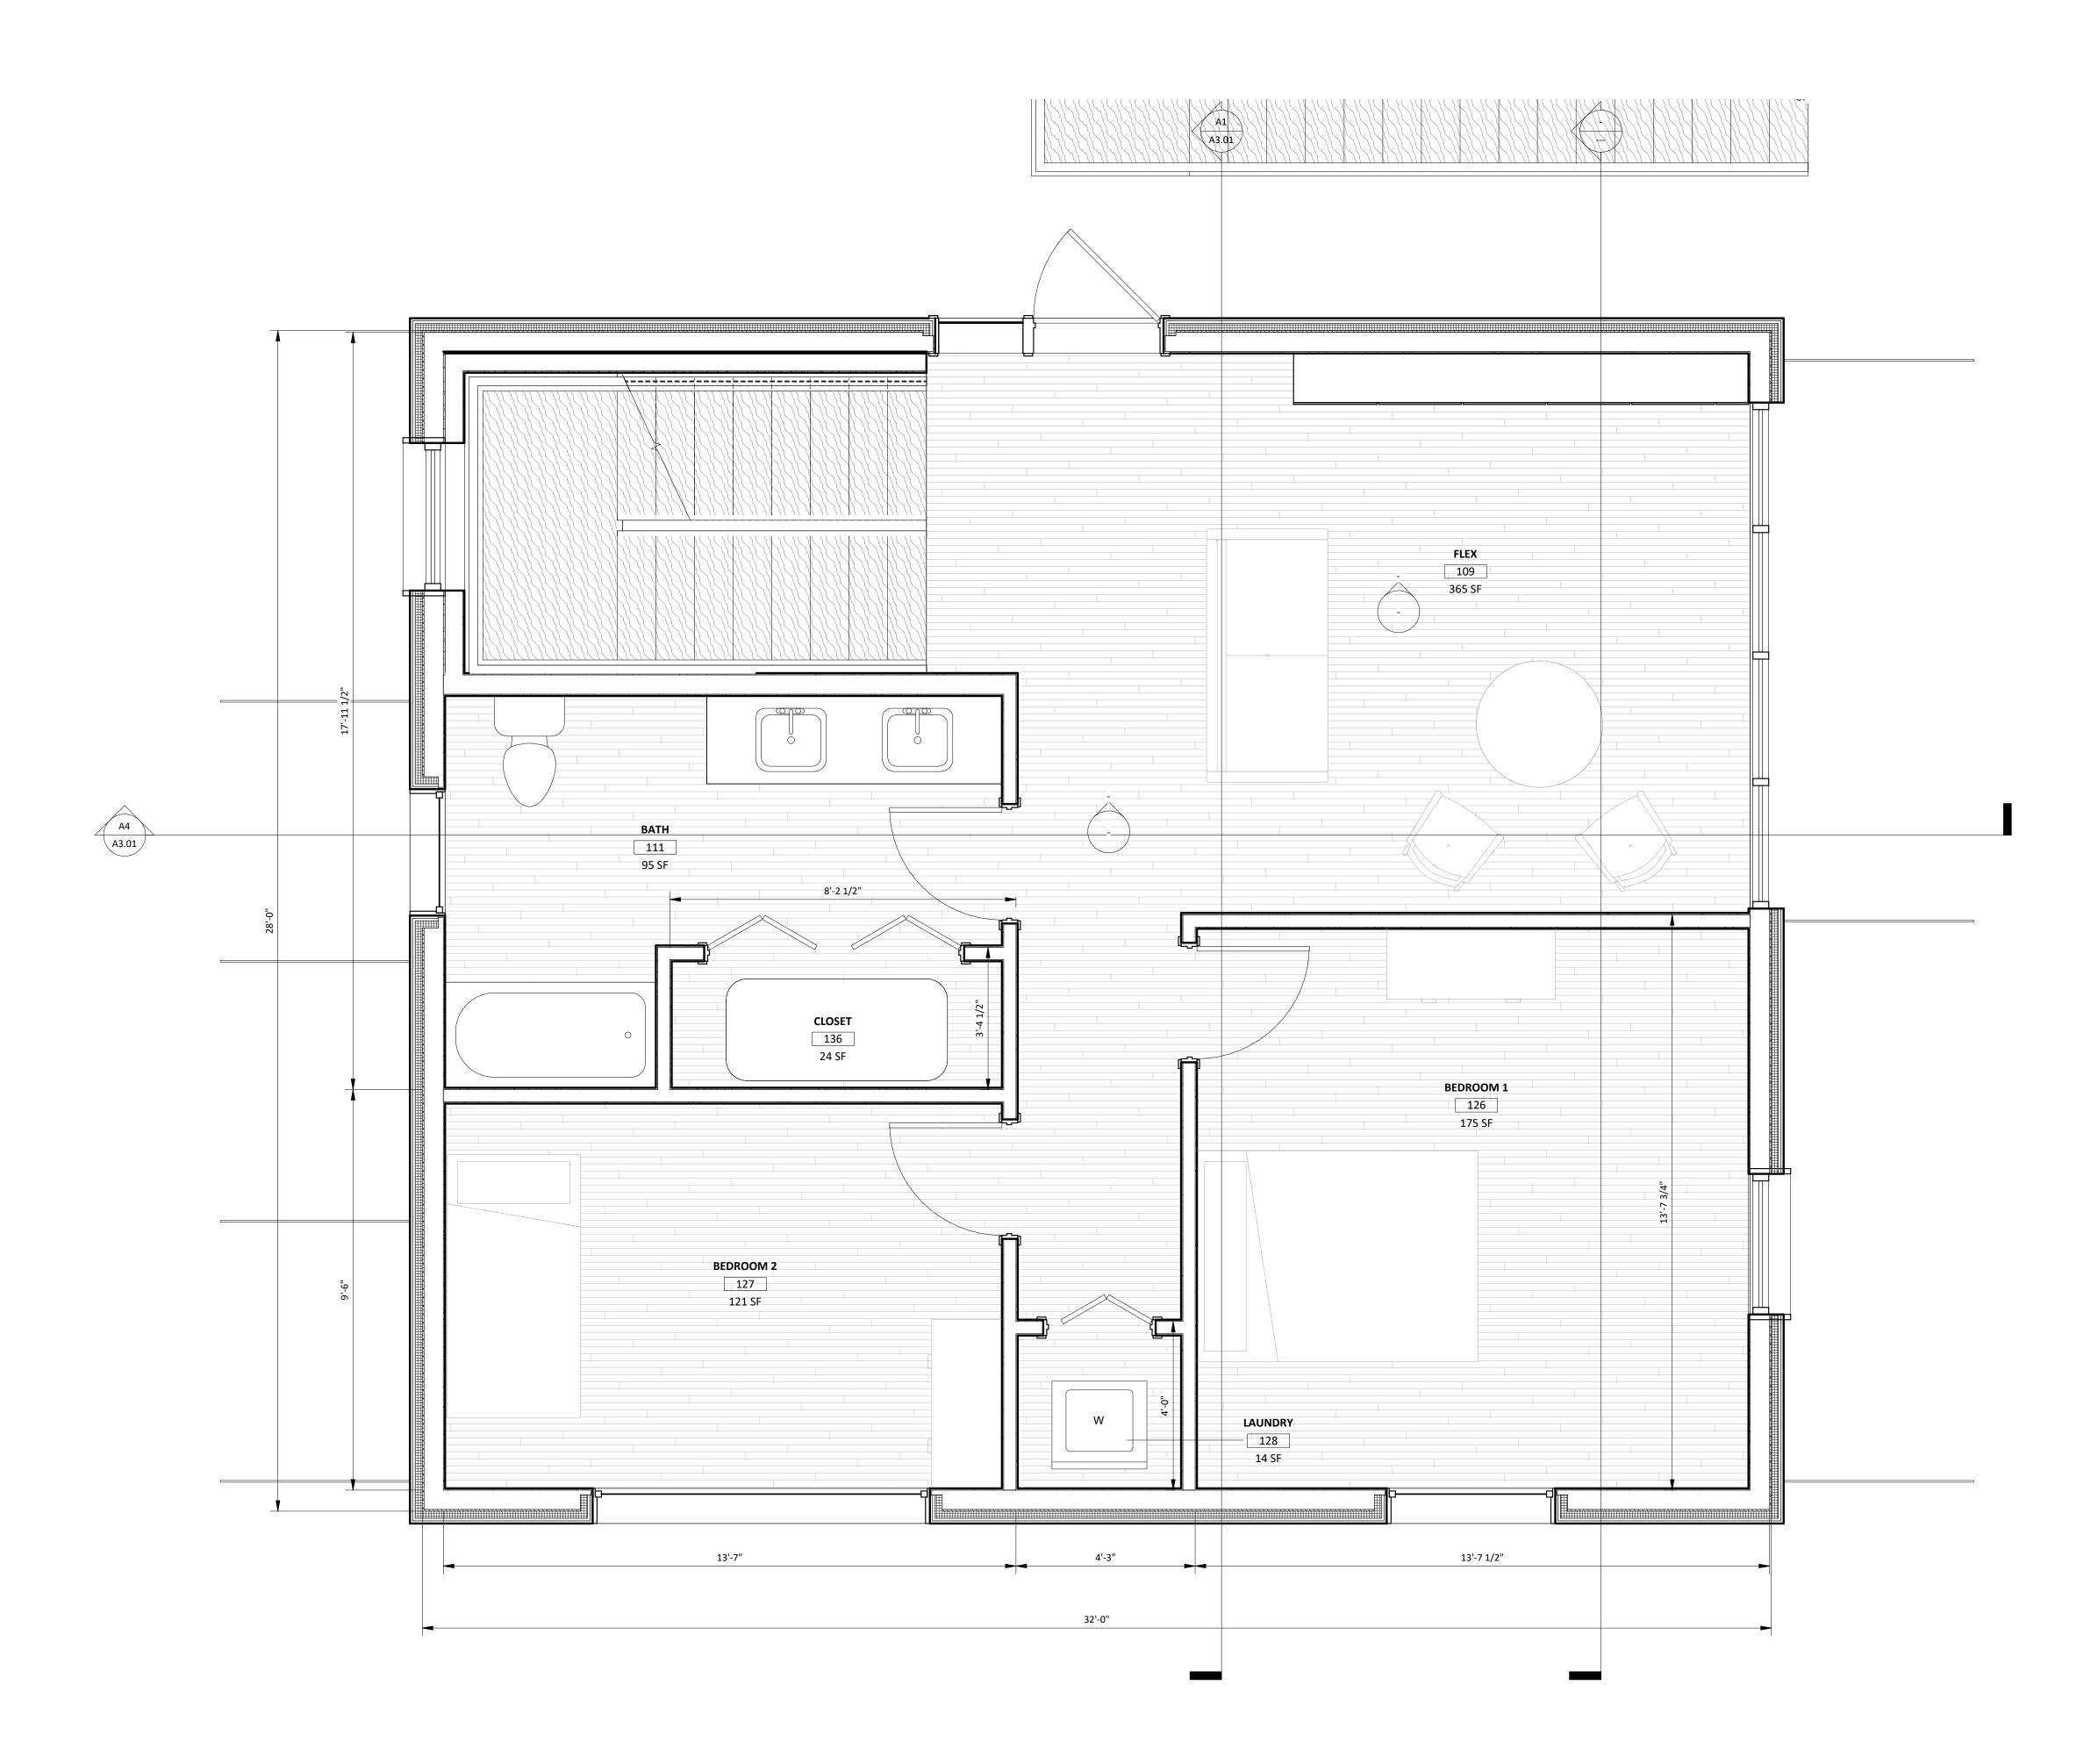PROJECT ADDRESS: **CLIENT NAME:** PETER & URSULA 33 MAPLEWOOD RD, BROWNING ITHACA, NY 14850

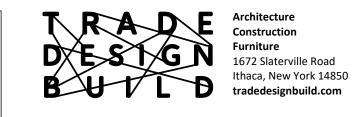CONSULTANT DETAILS

REVISION SCHEDULE

REVISION NO.

DRAWING DETAILS


DRAWING NAME: SECOND FLOOR PLAN

DRAWING NO:

ISSUE DATE: SEPTEMBER 19, 2025

DRAWN BY:


ISSUE DATE

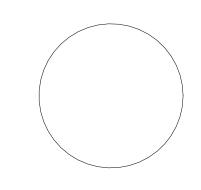

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SECOND FLOOR PLAN
1/2" = 1'-0"



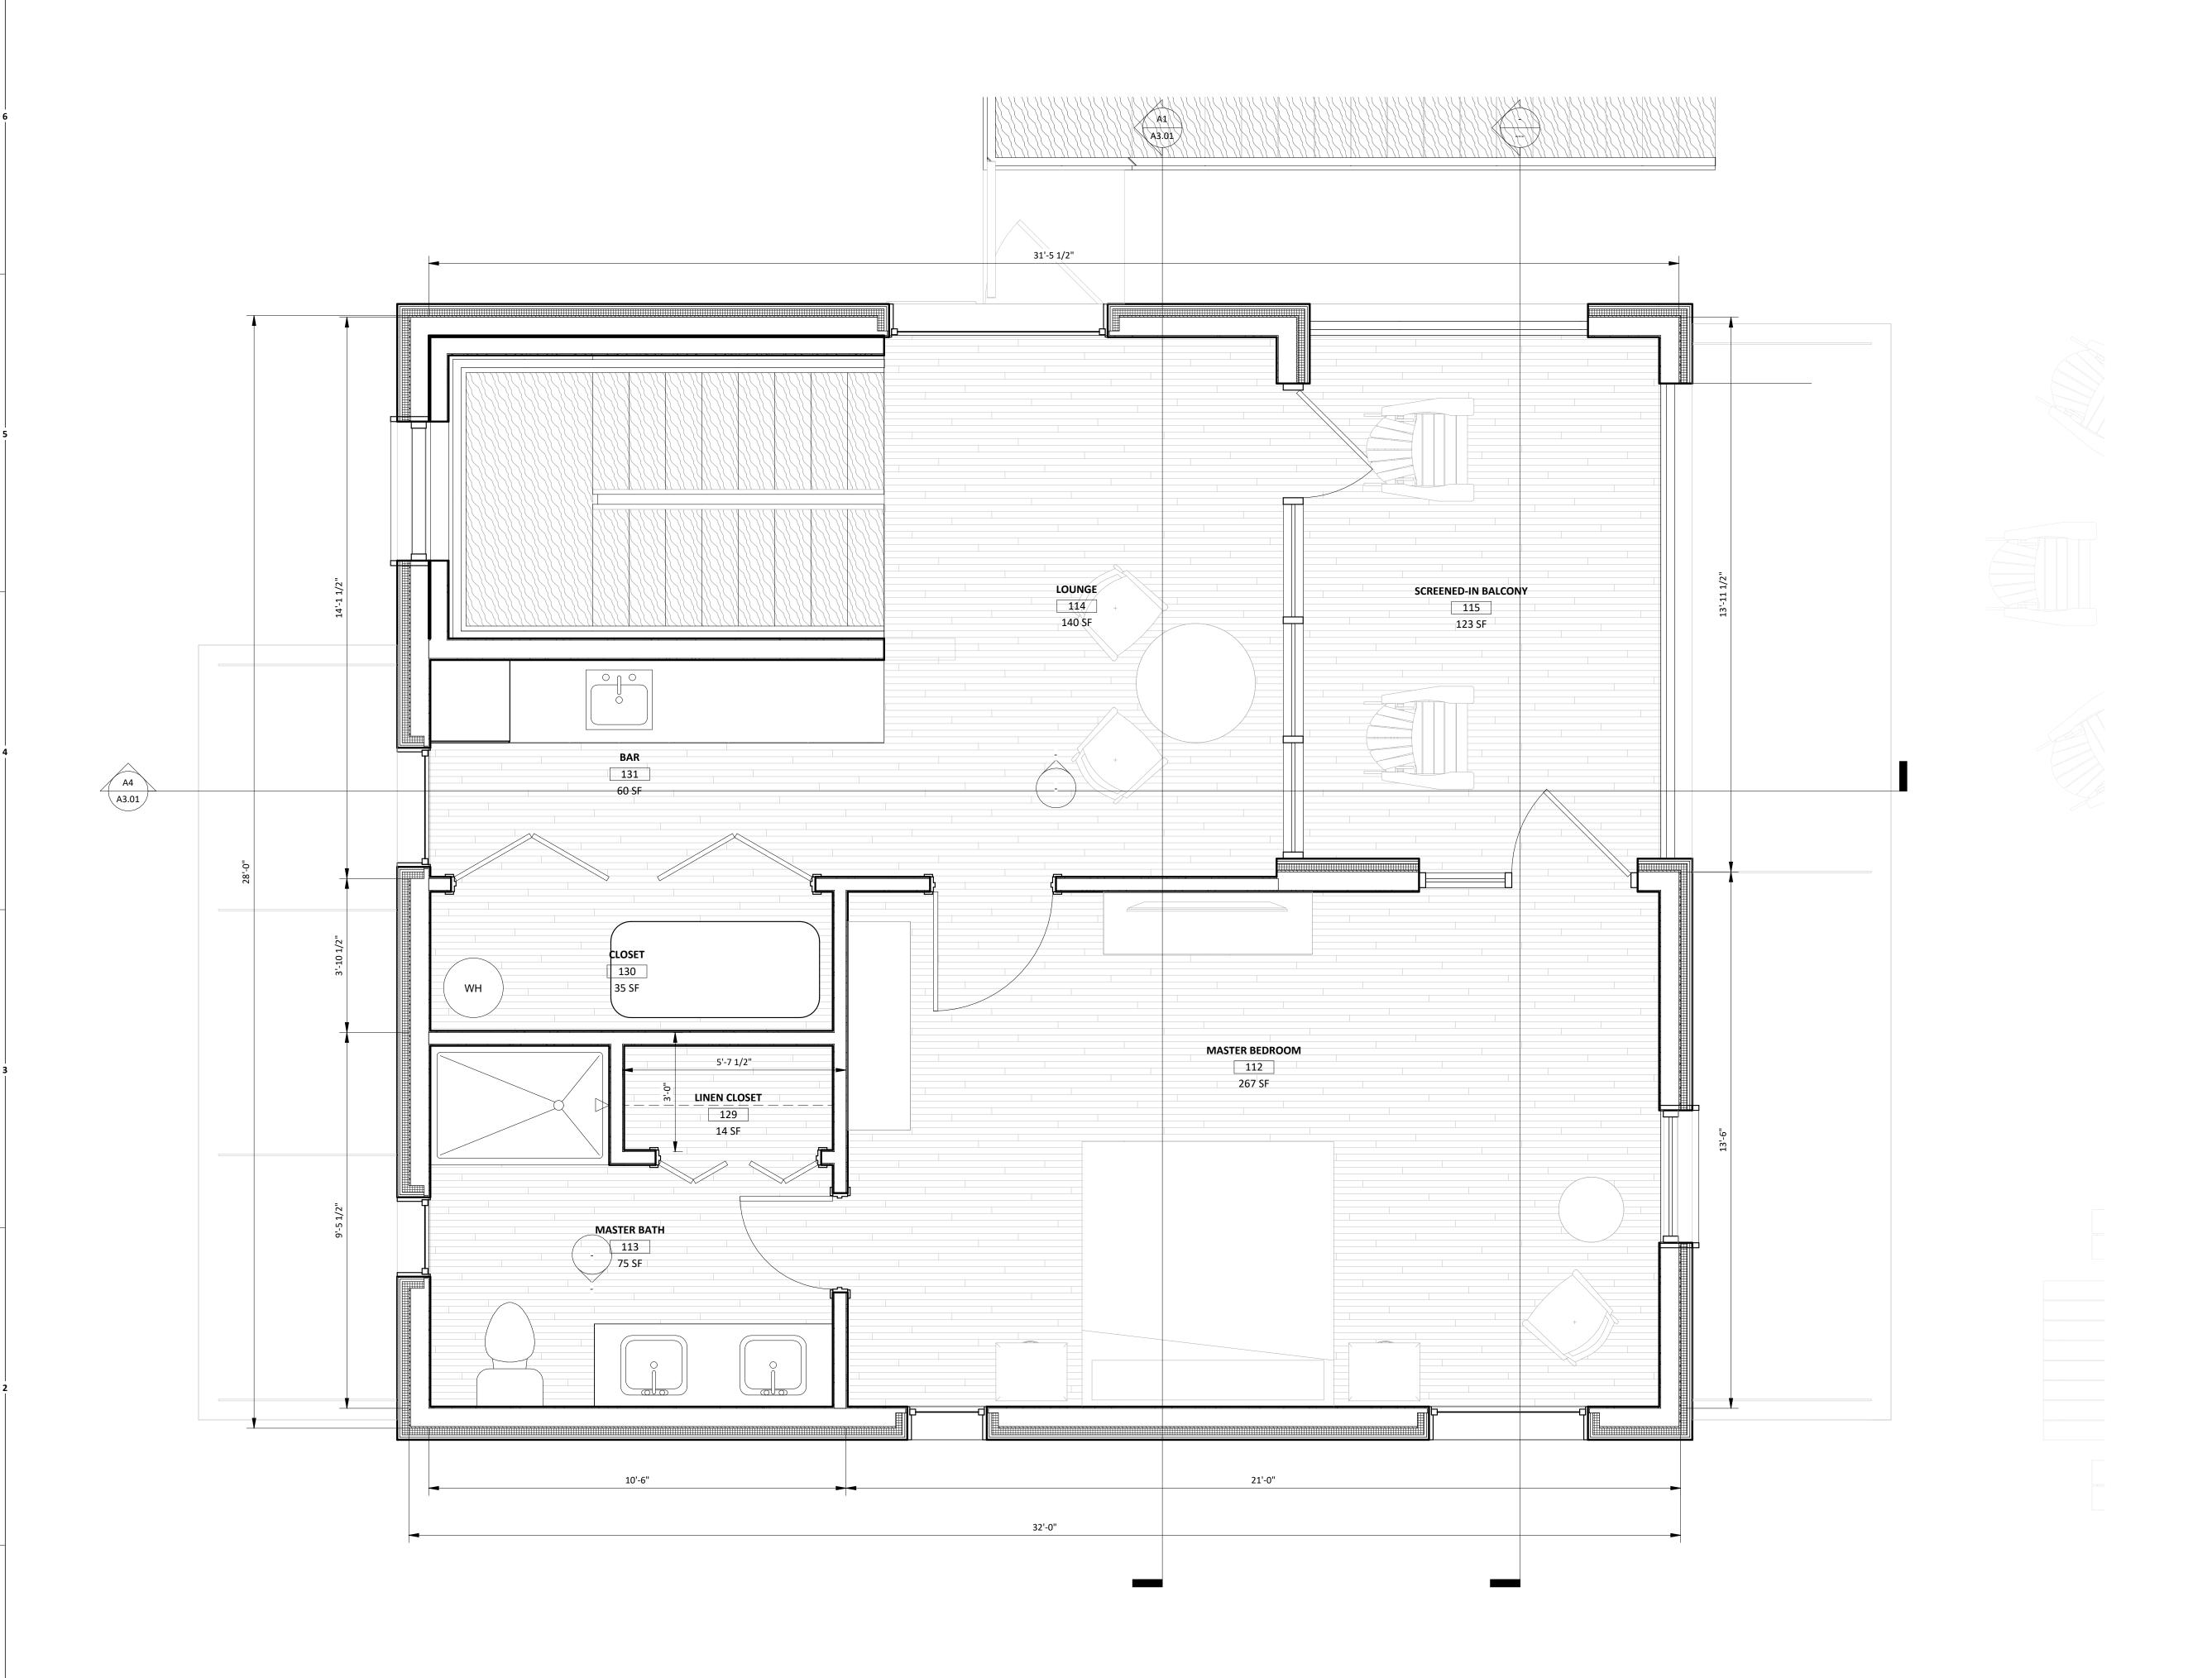

PROJECT NAME:

BROWNING MAPLEWOOD 25008

PROJECT ADDRESS: **CLIENT NAME:** PETER & URSULA 33 MAPLEWOOD RD, BROWNING ITHACA, NY 14850

CONSULTANT DETAILS

REVISION SCHEDULE

REVISION NO.

DRAWING DETAILS

DRAWING NAME: THIRD FLOOR PLAN

DRAWING NO:

ISSUE DATE

ISSUE DATE:

SEPTEMBER 19, 2025

DRAWN BY:

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A1 THIRD FLOOR PLAN
1/2" = 1'-0"



PROJECT NAME:

PROJECT NO: BROWNING MAPLEWOOD 25008

PROJECT ADDRESS: **CLIENT NAME:** PETER & URSULA 33 MAPLEWOOD RD, BROWNING ITHACA, NY 14850

CONSULTANT DETAILS

REVISION SCHEDULE

DRAWING DETAILS


DRAWING NAME:

DRAWING NO:

ISSUE DATE:

SEPTEMBER 19, 2025

ISSUE DATE

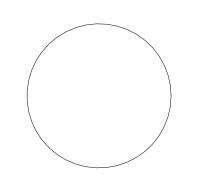

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EXISTING CONDITIONS



AGRICULTURAL DATA STATEMENT

PLANNING AND ZONING DEPARTMENT


Certain lands in the Town of Ulysses lie in an area that has been designated as an Agricultural District. Section 283-a of the New York State Town Law requires any application for a Special Permit, Site Plan, Use Variance or Subdivision on property within such a District containing a farm operation or on property with boundaries within five hundred (500) feet of a farm operation located in such a District to include an Agricultural Data Statement.

"Farming operations" are defined by Section 301, Article 25AA of the New York State Agriculture and Markets Law as "... the land used in agricultural production, farm buildings, equipment and farm


F. Attach a tax map showing the site of the proposed project relative to the location of the Farm Operations identified above.





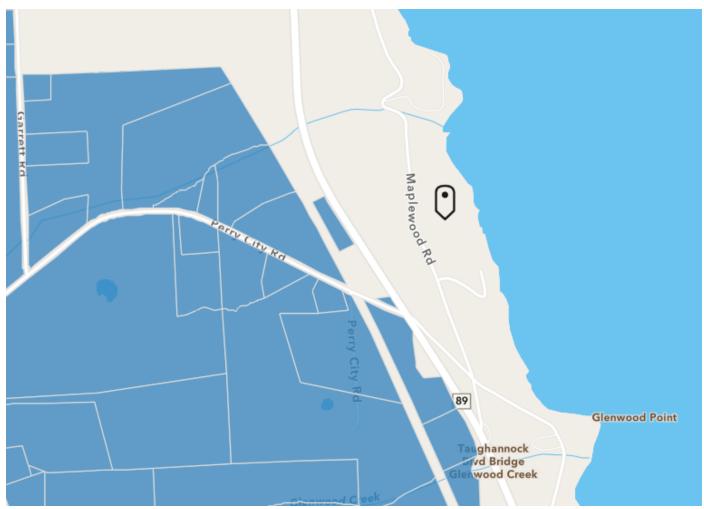


Town's Ag District Map

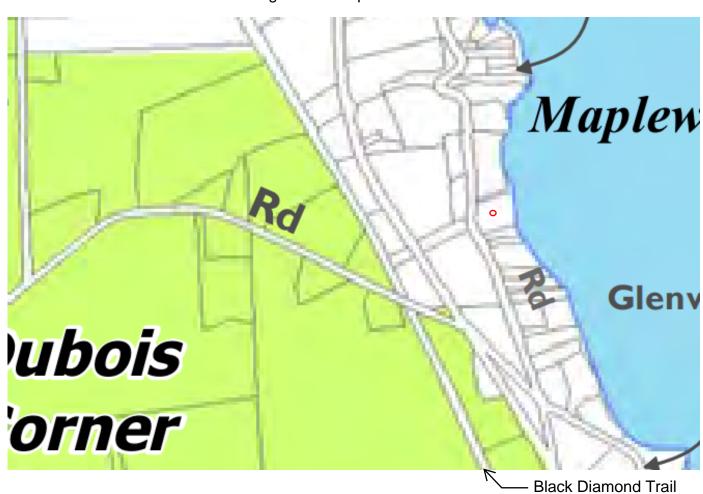

Google Maps



Snip from Flood Plain Map

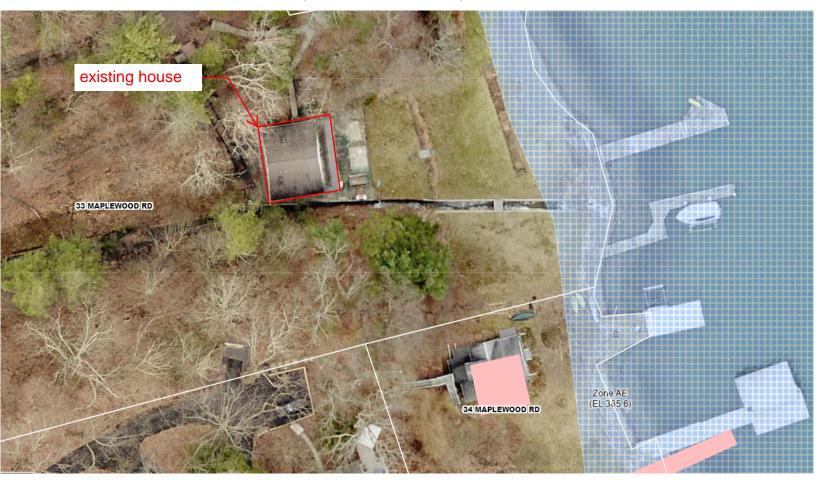

Short Environmental Assessment Form Part 1 - Project Information

Instructions for Completing

Part 1 – Project Information. The applicant or project sponsor is responsible for the completion of Part 1. Responses become part of the application for approval or funding, are subject to public review, and may be subject to further verification. Complete Part 1 based on information currently available. If additional research or investigation would be needed to fully respond to any item, please answer as thoroughly as possible based on current information.


Complete all items in Part 1. You may also provide any additional information which you believe will be needed by or useful to the lead agency; attach additional pages as necessary to supplement any item.

Part 1 – Project and Sponsor Information							
Name of Action or Project:							
Project Location (describe, and attach a location ma	np):						
Brief Description of Proposed Action:							
Name of Applicant or Sponsor:			Ι				
Name of Applicant of Sponsor.			Teleph	ione:			
			E-Mai	l:			
Address:							
City/PO:			State:		Zip C	ode:	
1. Does the proposed action only involve the legis	slative adoption	of a plan, loca	l law, or	dinance,		NO	YES
administrative rule, or regulation? If Yes, attach a narrative description of the intent of	f the proposed ac	ction and the e	nvironm	ental resources th	at		
may be affected in the municipality and proceed to							
2. Does the proposed action require a permit, appr If Yes, list agency(s) name and permit or approval:	roval or funding	from any othe	er goveri	nment Agency?	ŀ	NO	YES
3. a. Total acreage of the site of the proposed action? acres b. Total acreage to be physically disturbed? acres							
c. Total acreage (project site and any contiguous or controlled by the applicant or project sp		vned		acres			
4. Check all land uses that occur on, are adjoining	or near the prop	osed action:					
☐ Urban Rural (non-agriculture)	Industrial	Commercia	al l	Residential (subur	rban)		
☐ Forest Agriculture	Aquatic	Other(Spec	cify):				
Parkland							

Page 1 of 3 SEAF 2019

5.	Is the proposed action,	NO	YES	N/A
	a. A permitted use under the zoning regulations?			
	b. Consistent with the adopted comprehensive plan?			
			NO	YES
6.	Is the proposed action consistent with the predominant character of the existing built or natural landscape?			
7.	Is the site of the proposed action located in, or does it adjoin, a state listed Critical Environmental Area?		NO	YES
If Ye	es, identify:			
			170	
8.	a. Will the proposed action result in a substantial increase in traffic above present levels?		NO	YES
	b. Are public transportation services available at or near the site of the proposed action?			
	c. Are any pedestrian accommodations or bicycle routes available on or near the site of the proposed action?			
9.	Does the proposed action meet or exceed the state energy code requirements?		NO	YES
If the	ne proposed action will exceed requirements, describe design features and technologies:			
10.	Will the proposed action connect to an existing public/private water supply?		NO	YES
	If No, describe method for providing potable water:			
11.	Will the proposed action connect to existing wastewater utilities?		NO	YES
	If No, describe method for providing wastewater treatment:			
12.	a. Does the project site contain, or is it substantially contiguous to, a building, archaeological site, or district		NO	YES
	ch is listed on the National or State Register of Historic Places, or that has been determined by the nmissioner of the NYS Office of Parks, Recreation and Historic Preservation to be eligible for listing on the	·		
	e Register of Historic Places?	,		
	b. Is the project site, or any portion of it, located in or adjacent to an area designated as sensitive for			
arch	naeological sites on the NY State Historic Preservation Office (SHPO) archaeological site inventory?			
	a. Does any portion of the site of the proposed action, or lands adjoining the proposed action, contain wetlands or other waterbodies regulated by a federal, state or local agency?		NO	YES
	b. Would the proposed action physically alter, or encroach into, any existing wetland or waterbody?			
If Ye	es, identify the wetland or waterbody and extent of alterations in square feet or acres:			

14. Identify the typical habitat types that occur on, or are likely to be found on the project site. Check all that apply:		
☐Shoreline ☐ Forest Agricultural/grasslands Early mid-successional		
Wetland Urban Suburban		
15. Does the site of the proposed action contain any species of animal, or associated habitats, listed by the State or	NO	YES
Federal government as threatened or endangered? Bald Eagle, Lake Sturgeon		
16. Is the project site located in the 100-year flood plan?	NO	YES
17. Will the proposed action create storm water discharge, either from point or non-point sources? If Yes,	NO	YES
11 163,		
a. Will storm water discharges flow to adjacent properties?		
b. Will storm water discharges be directed to established conveyance systems (runoff and storm drains)? If Yes, briefly describe:		
18. Does the proposed action include construction or other activities that would result in the impoundment of water	NO	YES
or other liquids (e.g., retention pond, waste lagoon, dam)?	110	TLS
If Yes, explain the purpose and size of the impoundment:		
49. Has the site of the proposed action or an adjoining property been the location of an active or closed solid waste	NO	YES
management facility? If Yes, describe:		
ii Tes, describe.		
20. Has the site of the proposed action or an adjoining property been the subject of remediation (ongoing or	NO	YES
completed) for hazardous waste? If Yes, describe:		
I CERTIFY THAT THE INFORMATION PROVIDED ABOVE IS TRUE AND ACCURATE TO THE BE MY KNOWLEDGE	ST OF	
Applicant/sponsor/name: <u>Date:</u>		
Signature:Title:Title:		

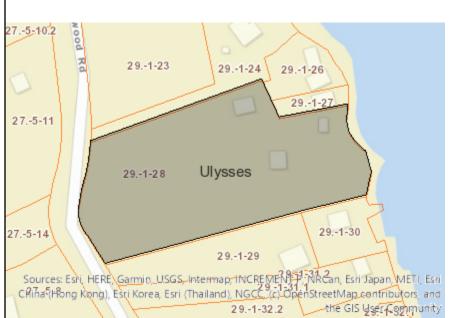

Disclaimer: The EAF Mapper is a screening tool intended to assist project sponsors and reviewing agencies in preparing an environmental assessment form (EAF). Not all questions asked in the EAF are answered by the EAF Mapper. Additional information on any EAF question can be obtained by consulting the EAF Workbooks. Although the EAF Mapper provides the most up-to-date digital data available to DEC, you may also need to contact local or other data sources to confirm data provided by the Mapper or to obtain data not provided by the Mapper.



Part 1 / Question 7 [Critical Environmental Area]	No
Part 1 / Question 12a [National or State Register of Historic Places or State Eligible Sites]	No
Part 1 / Question 12b [Archeological Sites]	Yes
Part 1 / Question 13a [Wetlands or Other Regulated Waterbodies]	Yes - Digital mapping information on local, New York State, and federal wetlands and waterbodies is known to be incomplete. Refer to the EAF Workbook.
Part 1 / Question 15 [Threatened or Endangered Animal]	Yes
Part 1 / Question 15 [Threatened or Endangered Animal - Name]	Bald Eagle, Lake Sturgeon
Part 1 / Question 16 [100 Year Flood Plain]	Digital mapping data are not available or are incomplete. Refer to EAF Workbook.
Part 1 / Question 20 [Remediation Site]	No

FROM THE DESK OF

Peter Browning

October 28, 2025

To Whom it May Concern,

My wife and and I are owners of the property at 33 Maplewood Road, Ithaca New York 14850. We have hired the firm Trade Design Build to create plans for our remodel of the existing space. We authorize representatives of Trade Design Build to represent us in securing permits, design approvals and whatever authorizations needed to make our plans come to life.

Sincerely yours,

Peter Browning

Ursula Kurman Browning



BOARD/COMMISSION MEMBER SITE VISIT

PLANNING AND ZONING DEPARTMENT

As part of their responsibilities for reviewing your application, members of Boards and Commissions may need to conduct site visits of the subject property to enable them to observe the property and the context of the neighborhood and adjacent properties. Some applications involve a project that is not wholly visible from the public right-of-way and it may be necessary for members to access your property to observe portions of the exterior of the property not visible from the right-of-way.

By signing below, you are attesting that you understand this information and authorize members to enter onto the property, including side and rear yards, as necessary to conduct their site visit for your application.

Signature of Property Owner

PETER BROWNING

33 Maplewood Rd

Please note, that if the property owner does not authorize the members to access your property, you may be required to provide additional information including photographic evidence of all areas of your property not visible from the right-of-way. Failure to permit property access to members or to provide additional information including adequate photographic evidence, may result in the denial of your application if there is insufficient evidence to establish that the standards have been met.



10/29/25



SKETCH SITE PLAN APPLICATION CHECKLIST

PLANNING AND ZONING DEPARTMENT

INSTRUCTIONS: Submit the following items listed in the checklist below. Electronic submittal via email is preferred. Hard copies may be submitted by mail or in person; however, digital files of all hard copies will be required to be submitted.

APPLICATION CHECKLIST				
X	1. Application	The <u>application sheet</u> must be filled out completely and signed by the owner, applicant, or primary contact.		
X	2. Property Owner Letter	If the applicant is not the property owner, written approval from the owner to submit the application must be submitted.		
X	3. Fees	\$200 + costs for new site plan proposals. \$100 + costs for amendments to approved site plans.		
X	4. Sketch Site Plan	A sketch site plan, drawn in accordance with the <u>Sketch Site Plan Requirement Checklist</u> .		
X	5. SEAF	Complete, sign, and date <u>Part 1 of the short environmental assessment form</u> along with <u>supporting documentation</u> ,		
X	6. Agriculture Data Statement	Complete and sign the <u>agricultural data statement</u> if the subject property contains a farm operation or is within 500 feet of a farm operation within a County designated agricultural district.		
X	7. Narrative Statement	A typed narrative that describes the proposed project.		
X	8. Conceptual Stormwater Management Plan	Submit a conceptual stormwater management plan that outlines the approach to manage runoff and its post construction treatment on the site.		
	9. Additional Information	 The following additional items may be required: Floodplain Elevation Geotechnical Assessment or Report Grading, fill, excavation data and associated Temporary Erosion and Sediment Control Plan (TESC) Stream/Wetland Delineation/Report (please note, if there appears to be State jurisdictional wetlands and/or associated buffers that impact the property, a DEC Jurisdictional Determination and/or Wetland Permit will be required to be submitted with the Final Site Plan Application. 		
X	10. Site Visit Form	Please review and complete this form.		

If this checklist or any of the items above are not included with your application submittal, your application may be deemed "incomplete" and returned to you.





